CITY OF DAISETTA, TEXAS

ROAD REHABILITATION PROJECT TEXAS GENERAL LAND OFFICE CDBG-DR PROGRAM CONTRACT NO. 24-067-004-E191

LJA PROJECT NO. B1246-1004

CITY OF DAISETTA OFFICIALS

410B MAIN STREET DAISETTA, TX 77533

MAYOR CHANCIE BAILEY

CINDY BURCHFIELD MAYOR PRO TEM

COUNCIL MEMBER

RYAN TAYLOR

COUNCIL MEMBER

LORI TIDWELL

COUNCIL MEMBER


VACANT

ANDREW MCCLUSKY COUNCIL MEMBER

COUNCIL MEMBER

GRANT ADMINISTRATION


TRAYLOR & ASSOCIATES GRANT MANAGEMENT

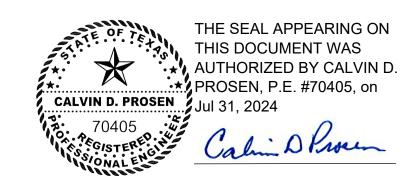

LJA ENGINEERING, INC.

CALVIN D. PROSEN, P.E., NO. 70405

07/31/2024 DATE

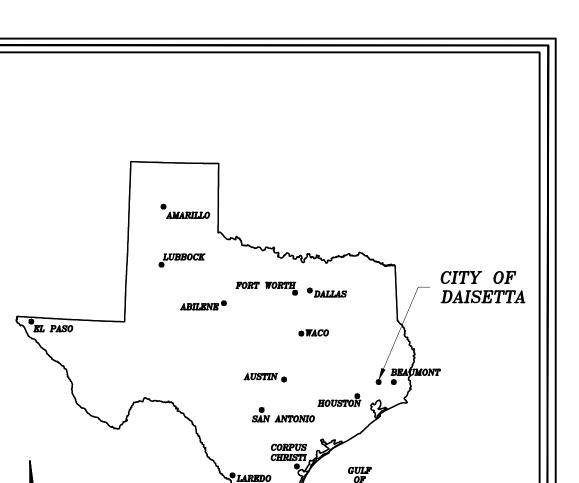

PROJECT MAP

PREPARED BY:

LJA ENGINEERING, INC.

CONSULTING ENGINEERS 2615 CALDER AVENUE, SUITE 500 BEAUMONT, TEXAS 77702 Texas Registered Engineering Firm FRN-F-1386

JULY 2024

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CITY OF DAISETTA,	TEXAS
ROAD REHABILITATION P	ROJECT

TITLE SHEET

LJA Engineering, Inc.

2615 Calder Avenue, Suite 500 Beaumont, Texas 77702

Fax 409.833.031 FRN - F-138 JOB NO.: B1246-1004

DESIGN: T.G. DRAWN: B.D.S. DATE: JULY 2024 CHECKED: T.G. SCALE: N.T.S. APPROVED: C.D.P. SHEET NO. 01 OF



GENERAL NOTES:

- 1. CONSTRUCTION SHALL BE IN ACCORDANCE WITH THESE PLANS AND SPECIFICATIONS, TXDOT STANDARD SPECIFICATIONS WHERE REFERENCED AND CITY OF DAISETTA REQUIREMENTS.
- 2. ALL BIDDERS ARE TO INSPECT THE PROJECT SITE AND FAMILIARIZE THEMSELVES WITH THE PLANS AND NATURE OF THE WORK PRIOR TO BIDDING. BIDDER SHALL VERIFY ALL QUANTITIES OF PROPOSED WORK. BIDS SHALL INCLUDE ALL COSTS FOR MOBILIZATION, TRAFFIC CONTROL, MATERIAL TESTING AND SWPPP NECESSARY FOR A COMPLETE PROJECT.
- 3. CONTRACTOR SHALL CONTACT THE ENGINEER AND CITY OF DAISETTA 48 HOURS PRIOR TO CONSTRUCTION FOR NOTIFICATION OF COMMENCEMENT.
- 4. LOCATION OF EXISTING UNDERGROUND UTILITIES AND SERVICE LINES (WATER, SEWER, GAS, TELEPHONE, ELECTRICAL, ETC.) ARE DETERMINED FROM BEST AVAILABLE RECORDS AND ARE APPROXIMATE. CONTRACTOR TO LOCATE LINES AND/ OR OBSTRUCTIONS AHEAD OF EXCAVATION.
- 5. THE CONTRACTOR SHALL HAVE FULL RESPONSIBILITY FOR TESTING ALL MATERIALS INCORPORATED IN THE PROJECT AT HIS SOLE EXPENSE. AN INDEPENDENT TESTING LABORATORY SHALL BE SELECTED BY THE CONTRACTOR, WITH THE ENGINEER'S APPROVAL, TO INSPECT AND TEST THE MATERIALS AND METHODS OF CONSTRUCTION. ALL COPIES OF REQUIRED TEST RESULTS ARE TO BE SENT TO THE ENGINEER DIRECTLY FROM THE TESTING AGENCY.
- 6. ALIGNMENT AND GRADES WILL GENERALLY FOLLOW THE EXISTING ROADWAY UNLESS NOTED. CONSTRUCTION STAKING (ALIGNMENT AND GRADE) TO BE PROVIDED BY THE CONTRACTOR AT NO SEPARATE PAY.
- 7. CONTRACTOR TO USE CAUTION WHEN CROSSING ALL EXISTING FACILITIES. ANY DAMAGE TO BE REPAIRED AT THE CONTRACTORS EXPENSE WITH NO SEPARATE PAY.
- 8. SURPLUS EXCAVATED MATERIAL SHALL BE REMOVED AND DISPOSED OFF SITE BY THE CONTRACTOR (NO SEPARATE PAY). IF THE ENGINEER NOTIFIES THE CONTRACTOR THAT THE OWNER HAS USE FOR THIS MATERIAL, THE MATERIAL WILL BE HAULED TO A SITE AS DIRECTED BY THE OWNER. NO FILL SHALL BE PLACED WITHIN ANY FLOODPLAIN HAZARD AREA.
- WHERE CONTRACTOR'S WORK AND/OR EQUIPMENT CAUSES AN OBSTRUCTION TO TRAFFIC, CONTRACTOR SHALL PROVIDE AND INSTALL TRAFFIC CONTROL DEVICES IN ACCORDANCE WITH PART IV OF THE "TEXAS MANUAL ON UNIFORM TRAFFIC CONTROL DEVICES" (TEXAS MUTCD, MOST RECENT EDITION AS REVISED) DURING CONSTRUCTION.
- 10. CONTRACTOR TO MAINTAIN ACCESS FOR PROPERTY OWNERS, POST OFFICE VEHICLES, SCHOOL BUSES, GARBAGE TRUCKS AND EMERGENCY VEHICLES AT ALL TIMES.
- 11. NOTIFY ALL PROPERTY OWNERS A MINIMUM OF TWENTY-FOUR (24) HOURS PRIOR TO BLOCKAGE OF DRIVEWAYS OR ENTERING OF UTILITY EASEMENTS.
- 12. CONTRACTOR SHALL MAINTAIN DRAINAGE TO ORIGINAL OR BETTER CONDITION THROUGHOUT THE CONSTRUCTION OF THE PROJECT. NO SEPARATE PAY.
- 13. ALL TRAFFIC SIGNS AND STRIPING SHALL CONFORM TO THE TEXAS MANUAL ON UNIFORM TRAFFIC CONTROL DEVICES.
- 14. THE CONTRACTOR TO PROVIDE ACCESS TO EXISTING DRIVEWAYS AT ALL TIMES. ALL WEATHER GRAVEL SURFACE SHALL BE USED FOR MAINTAINING TEMPORARY ACCESS TO EXISTING DRIVEWAYS. THIS WORK WILL NOT BE PAID FOR DIRECTLY BUT SHALL BE SUBSIDIARY TO THE VARIOUS BID ITEMS OF THE CONTRACT.
- 15. CONTRACTOR TO CONTACT "DIG-TESS" AT 1-800-344-8377 OR 811 AT LEAST 48 HOURS PRIOR TO BEGINNING ANY CONSTRUCTION FOR LOCATION AND MARKING OF UNDERGROUND CABLE.
- 16. PROTECT EXISTING UTILITIES FROM DAMAGE DURING CONSTRUCTION. UTILITIES DAMAGED ARE TO BE REPAIRED BY THE CONTRACTOR AT HIS EXPENSE. VERIFY THE LOCATION AND DEPTH OF EXISTING UTILITIES PRIOR TO CONSTRUCTION.
- 17. EXISTING MAILBOXES, SIGNS, VALVE BOXES, ETC. DISTURBED BY CONTRACTOR SHALL BE CONSIDERED INCIDENTAL TO CONSTRUCTION AND SHALL BE RESET AT THE CONTRACTOR'S EXPENSE.
- 18. CONTRACTOR SHALL KEEP THE PROJECT SITE AS CLEAN AS POSSIBLE DURING WORK. UPON PROJECT COMPLETION, ALL WORK AREA MUST BE LEFT AS CLEAN AS PRE -EXISTING CONDITION.
- 19. WATER TRUCKS EQUIPPED WITH WATER SPRINKLING SYSTEMS SHALL BE SUPPLIED BY THE CONTRACTOR TO MINIMIZE DUST DURING CONSTRUCTION AND SHALL BE CONSIDERED SUBSIDIARY TO VARIOUS BID ITEMS.
- 20. A FIELD SET OF AS-BUILT DRAWINGS SHALL BE MAINTAINED BY THE CONTRACTOR FOR TRANSFER TO PERMANENT RECORD DRAWINGS. THESE DRAWINGS SHOULD INCLUDE CHANGES MADE DURING CONSTRUCTION. PROJECT WILL NOT BE CLOSED OUT UNTIL CONTRACTOR HAS PROVIDED THE FIELD SET TO THE ENGINEER.
- 21. REMOVAL OF DEFECTIVE AND UNAUTHORIZED WORK: ALL WORK WHICH HAS BEEN REJECTED OR CONDEMNED SHALL BE REPAIRED; OR IF IT CANNOT BE REPAIRED SATISFACTORILY, IT SHALL BE REMOVED AND REPLACED AT THE CONTRACTOR'S EXPENSE. DEFECTIVE MATERIALS SHALL BE IMMEDIATELY REMOVED FROM THE WORK SITE. WORK DONE BEYOND THE LINE OR NOT IN CONFORMITY WITH THE GRADES SHOWN ON THE DRAWINGS OR AS PROVIDED, WORK DONE WITHOUT PROPER INSPECTION; OR ANY EXTRA OR UNCLASSIFIED WORK DONE WITHOUT WRITTEN AUTHORITY AND PRIOR AGREEMENT IN WRITING AS TO PRICES,

SHALL BE AT THE CONTRACTOR'S RISK, AND WILL BE CONSIDERED UNAUTHORIZED, AND AT THE OPTION OF THE CLIENT MAY NOT BE MEASURED AND PAID FOR AND MAY BE ORDERED REMOVED AT THE CONTRACTOR'S EXPENSE. UPON FAILURE OF THE CONTRACTOR TO REPAIR SATISFACTORILY OR TO REMOVE AND REPLACE, IF SO DIRECTED, REJECTED, UNAUTHORIZED OR CONDEMNED WORK OR MATERIALS IMMEDIATELY AFTER RECEIVING NOTICE FROM THE CLIENT, THE CLIENT WILL, AFTER GIVING WRITTEN NOTICE TO THE CONTRACTOR, HAVE THE AUTHORITY TO CAUSE DEFECTIVE WORK TO BE REMEDIED OR REMOVED AND REPLACED, OR TO CAUSE UNAUTHORIZED WORK TO BE REMOVED AND TO DEDUCT THE COST THEREOF FROM ANY MONIES DUE OR TO BECOME DUE THE CONTRACTOR.

- 22. BEFORE EXCAVATING NEAR EXISTING UTILITIES, CONTACT THE UTILITY COMPANY FOR EXACT LOCATIONS TO PREVENT DAMAGE OR INTERFERENCE WITH PRESENT FACILITIES. NOTIFY TEXAS ONE CALL, TOLL FREE AT 1-800-245-4545. THIS ACTION DOES NOT RELIEVE THE CONTRACTOR OF THE RESPONSIBILITIES UNDER THE TERMS OF THE CONTRACT OR THE PLANS AND SPECIFICATIONS. DAMAGED CAUSED BY THE CONTRACTOR'S OPERATIONS SHALL BE REPAIRED AND RESTORED TO SERVICE IN A TIMELY MATTER AT NO EXPENSE TO THE CITY.
- 23. THE FOLLOWING IS A LIST OF CONTACTS:

CITY OF DAISETTA 936-536-6761 TEXAS ONE CALL SYSTEM 1-800-245-4545 DIG -TESS 1-800-344-8377 ENTERGY 1-800-ENTERGY

SIGNAGE REQUIREMENTS:

THE PROJECT SHALL PLACE TEMPORARY SIGNAGE ERECTED IN A PROMINENT LOCATION AT THE CONSTRUCTION PROJECT SITE OR ALONG A MAJOR THOROUGHFARE WITHIN THE LOCALITY. SIGNAGE SHALL CONTAIN THE FOLLOWING:



THIS PROJECT IS FUNDED BY THE TEXAS GENERAL LAND OFFICE OF THE STATE OF TEXAS, TO PROVIDE FOR DISASTER RECOVERY AND RESTORATION OF INFRASTRUCTURE FOR COMMUNITIES IMPACTED BY HURRICANE HARVEY.



FUNDS ALLOCATED BY THE UNITED STATES DEPARTMENT OF HOUSING AND URBAN DEVELOPMENT THROUGH THE COMMUNITY DEVELOPMENT BLOCK GRANT PROGRAM.

CONSTRUCTION NOTES:

ALL WORK SHALL BE PERFORMED IN ACCORDANCE WITH TXDOT'S STANDARD SPECIFICATIONS FOR CONSTRUCTION AND MAINTENANCE OF HIGHWAYS, STREETS AND BRIDGES. 2014 VERSION, EXCEPT AS REVISED OR CLARIFIED IN THE SUPPLEMENTAL NOTES THAT FOLLOW:

ITEM 134 – BACKFILLING PAVEMENT EDGES

PAYMENT FOR THIS BID ITEM IS FULL COMPENSATION FOR LABOR, MATERIAL EQUIPMENT, TOOLS AND INCIDENTALS. PROVIDE A SHOULDER-UP WIDTH NO GREATER THAN TWO (2) FEET. SHOULDER -UP MATERIAL SHALL MEET THE 95% STANDARD PROCTOR DENSITY REQUIREMENTS. THIS ITEM SHALL NOT BE PAID FOR DIRECTLY BUT SHALL BE CONSIDERED SUBSIDIARY TO VARIOUS BID ITEMS.

ACCEPTABLE SHOULDER -UP MATERIAL INCLUDES:

- LIMESTONE BASE, TYPE A , GRADE 1 -2 (TXDOT ITEM 247)
- RECYCLED ASPHALT PAVEMENT (RAP) (TXDOT ITEM 340)

ITEM 150 - BLADING

BLADE EXISTING SHOULDER OF ALL VEGETATION AND SOIL BUILDUP FOR A MINIMUM WIDTH OF 1 FOOT. THIS ITEM SHALL NOT BE PAID FOR DIRECTLY BUT SHALL BE CONSIDERED SUBSIDIARY TO VARIOUS BID ITEMS.

ITEM 247 – FLEXIBLE BASE

FLEXIBLE BASE FOR THIS PROJECT SHALL BE CRUSHED LIMESTONE BASE (TYPE A, GRADE 1-2). MEASUREMENT FOR PAYMENT OF FLEXIBLE BASE SHALL BE BY THE SQUARE YARD COMPLETE IN PLACE OF THE COMPACTED THICKNESS.

THE CONTRACTOR SHALL PLACE THE PROPOSED BASE IN NO GREATER THAN 6" LIFTS AND COMPACT EACH LIFT TO 95 % OF STANDARD PROCTOR DENSITY AS DETERMINED BY ASTM D-698. WHEN PLACEMENT OF BASE IS FINISHED AND DENSITY HAS BEEN ACHIEVED, AREA RECEIVING PRIME SHALL NOT BE PRIMED UNTIL THE BASE IS WITHIN ±2% OF OPTIMUM MOISTURE CONTENT.

ITEM 251 – REWORKING BASE COURSES

REWORKING BASE COURSE FOR THIS PROJECT SHALL INCLUDE PULVERIZING ALL EXISTING ASPHALT CONCRETE PAVEMENT SURFACE WITH EXISTING BASE IN PLACE WITH A MAXIMUM PARTICLE SIZE OF ½". THE ENTIRE EXISTING SURFACE COURSE AND THE EXISTING BASE SHALL BE PULVERIZED TO AN APPROXIMATE DEPTH OF EIGHT (8) INCHES USING A RECLAIMER (EITHER A

BOMAG MPH TYPE, CATERPILLAR RR TYPE, CEI TYPE, OR APPROVED EQUIVALENT). DEPTHS OF PULVERIZATION MAY NEED TO BE FIELD ADJUSTED ONCE CONSTRUCTION BEGINS. ANY ADJUSTMENTS SHALL BE CONSIDERED SUBSIDIARY TO THE BID ITEM WITH NO ADDITIONAL PAY. EXISTING BASE QUANTITIES HAVE BEEN ESTIMATED FROM TOPOGRAPHIC FIELD SURVEY COLLECTED. SHOULD THE CONTRACTOR BELIEVE THE QUANTITIES REPRESENTED DO NOT REFLECT EXISTING CONDITIONS, THE CONTRACTOR SHALL ADJUST HIS/HER UNIT PRICE BID FOR ITEM 251. NO ADDITIONAL PAYMENT SHALL BE MADE FOR REWORKING BASE COURSE OVER THE QUANTITY BID FOR THE PROJECT.

ITEM 310 – TRACKLESS TACK AS PRIME COAT

TRACKLESS TACK FOR THIS PROJECT SHALL BE SS-1H AND APPLIED AT THE RATE BETWEEN 0.04 TO 0.1 GAL/SY AND PLACED WHEN THE BASE IS WITHIN ± 2% OF OPTIMUM MOISTURE. BEFORE APPLYING THE TRACKLESS TACK, THE CONTRACTOR SHALL MAKE SURE THAT ALL LOOSE MATERIAL IS REMOVED FROM THE SURFACE BY LIGHTLY SWEEPING WITH A MECHANICAL BROOM.

FURNISHING AND PLACING BLOTTER MATERIAL WILL NOT BE PAID FOR SEPARATELY BUT SHALL BE CONSIDERED SUBSIDIARY TO THE UNIT PRICE BID FOR ITEM 310. FOR CONTRACTOR'S QUALITY CONTROL, THE PROJECT REPRESENTATIVE SHALL VERIFY THE APPLICATION RATE AT ANY TIME DURING CONSTRUCTION.

ITEM 340 – DENSE -GRADED HOT -MIX ASPHALT (SMALL QUANTITY)

PROVIDE MIXTURE TYPE D USING PG BINDER 64-22 OF COMPACTED ASPHALT THICKNESS AS SHOWN ON THE PLANS. USE TACK COAT/ASPHALT BINDER COMPATIBLE WITH TYPE OF MIX REQUIRED.

THE MIX SHALL BE DESIGNED FOR A STABILITY OF AT LEAST FORTY (40) AND COMPACTED TO BETWEEN 92% AND 97% OF THE MAXIMUM THEORETICAL DENSITY MEASURED BY ASTM D-2041.

SILICEOUS GRANITE OR GRAVEL, IRON ORE OR LIGHTWEIGHT MATERIAL, RAS MATERIALS WILL NOT BE USED ON THIS PROJECT.

ASPHALT CONCRETE WILL BE TESTED FOR DENSITY CONTROL AND COMPARISON TO THE JOB MIX FORMULA FOR FINAL ACCEPTANCE. ASPHALT WILL BE TESTED EACH 500 TONS OR ONE DAY PRODUCTION.

THE VERTICAL SURFACE EXPOSED WHEN TAKING THE CORE SAMPLE WILL BE COMPLETELY COATED WITH EPOXY AND REPAIRED TO THE SATISFACTION OF THE ENGINEER. THESE EXTRA WORKS (TESTING AND REPAIR) WILL NOT BE PAID FOR DIRECTLY BUT SHALL BE CONSIDERED SUBSIDIARY TO THE VARIOUS BID ITEMS. THE COARSE AGGREGATE USED ON THE PROJECT SHALL HAVE A COMBINED POLI- SH VALUE OF NOT LESS THAN 30 AND NONE OF THE INDIVIDUAL AGGREGATE THAT COMPOSE THE COARSE AGGREGATE SHALL HAVE A POLISH VALUE OF LESS THAN 29.

ALL ASPHALT COURSES SHALL BE PLACED WITH AN APPROVED SPREADING AND FINISHING MACHINE EQUIPPED WITH AN AUTOMATIC SCREED CONTROL IN ACCORDANCE WITH TXDOT ITEM 340.

IF THE EXISTING SURFACE TO BE OVERLAID CONTAINS HOLES OR

DEPRESSIONS EXCEEDING THREE-QUARTERS (3/4) INCH IN DEPTH, IT SHALL BE REPAIRED BY REMOVAL OF ALL LOOSE AND DEFECTIVE MATERIALS TO A DEPTH OF A MINIMUM OF EIGHT (8) INCHES AND REPLACED WITH EQUAL AMOUNT OF ASB GRADE 1 MATERIAL IN ACCORDANCE WITH TXDOT SPECIFICATION ITEM 292. REMOVAL OF LOOSE AND DEFECTIVE MATERIALS (REGARDLESS OF NATURE) WILL BE PAID UNDER RELATED ITEM.

TRUCKS HAULING BITUMINOUS MIXTURES SHALL HAVE TIGHT, CLEAN AND SMOOTH METAL BEDS TO PREVENT THE MIXTURE FROM ADHERING TO THEM. THE BEDS SHALL BE LIGHTLY COATED WITH A MINIMUM AMOUNT OF PARAFFIN OIL AND LIME SOLUTION. UNDER NO CIRCUMSTANCES SHALL THE USE OF DIESEL FUEL BE PERMITTED FOR THIS PURPOSE. EACH TRUCK SHALL HAVE A SUITABLE COVER TO PROTECT THE MIXTURE FROM ADVERSE WEATHER. ANY MIXTURE ARRIVING AT THE PAVER WITH A TEMPERATURE OF LESS THAN 275 DEGREES FAHRENHEIT WILL BE REJECTED.

THE FORMATION OF JOINTS (PARTICULARLY CENTERLINE JOINTS) SHALL BE MADE IN SUCH A MANNER AS TO ENSURE A CONTINUOUS BOND BETWEEN OLD AND NEW SECTIONS OF THE COURSE. ALL JOINTS SHALL PRESENT THE SAME TEXTURE, DENSITY, AND SMOOTHNESS AS THE OTHER SECTIONS OF THE ASPHALT CONCRETE PAVEMENT. TRANSVERSE AND LONGITUDINAL JOINTS SHALL HAVE A STRAIGHT VERTICAL FACE AND SHALL BE GIVEN A TACK COAT BEFORE PLACEMENT OF ANY FRESH MIXTURE AGAINST THE JOINT

THE BID QUANTITIES OF HOT MIX HAVE BEEN ESTIMATED AT THE RATE OF 2 TONS/CY. THE CONTRACTOR IS RESPONSIBLE FOR ADJUSTING HIS/HER UNIT PRICE FOR ITEM 341 TO TAKE INTO ACCOUNT THE WASTE MATERIAL REQUIRED TO PROVIDE A FINAL COMPACTED THICKNESS AS SHOWN IN THE PLANS.

RAP AND RAS SHALL NOT BE ALLOWED IN THE MIX FOR THIS PROJECT.

ITEM 351 – FLEXIBLE PAVEMENT STRUCTURE REPAIR

WHERE LOW PLASTIC MATERIALS SUCH AS SILTY SAND AND SANDY CLAY SOILS ARE ENCOUNTERED AT THE PAVEMENT SUBGRADE LEVEL, THE EXPOSED SURFACE OF THE PAVEMENT SHALL BE SCARIFIED TO A DEPTH OF 8 INCHES AND CHEMICALLY TREATED WITH PORTLAND CEMENT.

ITEM 500 – MOBILIZATION

MOBILIZATION SHALL NOT EXCEED 5% OF THE TOTAL BID FOR EACH ROADWAY.

ITEM 502 - BARRICADES, SIGNS, AND TRAFFIC HANDLING

THE TRAFFIC CONTROL PLAN SHALL CONFORM TO TXDOT'S BARRICADE AND CONSTRUCTION DETAILS 1 THROUGH 12-(21) AND PART IV OF THE "TEXAS MANUAL ON UNIFORM TRAFFIC CONTROL DEVICES" (TEXAS MUTCD, MOST RECENT EDITION AS REVISED) DURING CONSTRUCTION. CONTRACTOR SHALL IMPLEMENT PROPER DETOURS WHEN CLOSING INTERSECTIONS FOR WORK. CHANNELIZING DEVICES FOR LANE CLOSURE SHALL BE DRUMS WITH VERTICAL PANELS PER BC (8)-(21) OR PORTABLE VERTICAL PANELS PER BC (9)-21. REMOVE ALL TRAFFIC CONTROL DEVICES FROM THE ROADWAY, OFF THE RIGHT OF WAY, WHEN THEY ARE NOT IN USE.

ITEM 506 - TEMPORARY EROSION, SEDIMENTATION, AND ENVIRONMENTAL CONTROLS

PAYMENT FOR THIS BID ITEM SHALL BE FOR SW3P PREPARATION, MAINTENANCE AND REMOVAL. PROVIDE ADEQUATE EROSION CONTROL MEASURES NECESSARY TO CONTAIN SEDIMENT AND EROSION TO WITHIN THE PROJECT SITE.

ITEM 530 – INTERSECTIONS. DRIVEWAYS AND TURNOUTS


DRIVEWAY APRON CONSTRUCTION AND MATERIAL ARE BID SEPARATELY FROM ROADWAY ITEMS. CONTRACTOR SHALL INSTALL HMAC SURFACE AND TACK COAT. SWEEP DRIVEWAY PRIOR TO PLACEMENT OF SURFACE COURSE.

ITEM 5000 - CONSTRUCTION MATERIALS TESTING

CONSTRUCTION MATERIALS TESTING IS IMPERATIVE TO THE SUCCESSFUL CONSTRUCTION OF THE PROJECT. THE CONTRACTOR SHALL TEST ALL MATERIALS INCORPORATED IN THE PROJECT. AN INDEPENDENT TESTING LABORATORY SHALL BE SELECTED BY THE CONTRACTOR, WITH THE ENGINEER'S APPROVAL, TO INSPECT AND TEST THE MATERIALS AND METHODS OF CONSTRUCTION. ALL COPIES OF REQUIRED TEST RESULTS ARE TO BE SENT TO THE ENGINEER DIRECTLY FROM THE TESTING AGENCY.


PROJECT NOTES:

- 1. THE CONTRACTOR SHALL LIMIT DISTURBED AREAS TO THE RIGHT-OF-WAY. ANY AREAS DISTURBED OUTSIDE OF THE RIGHT-OF-WAY, UNLESS DIRECTED BY THE ENGINEER, SHALL BE RESTORED TO THE CONDITIONS PRIOR TO CONSTRUCTION AT THE CONTRACTOR'S EXPENSE.
- 2. THE RIGHT-OF-WAY SHOWN ON THESE PLANS HAVE NOT BEEN FIELD VERIFIED AND ARE BASED UPON ESTIMATES PROVIDED BY LIBERTY COUNTY APPRAISAL DISTRICT. THESE RIGHT-OF-WAYS DO NOT CONSTITUTE A BOUNDARY DECISION OF ANY KIND.
- 3. THE PROPOSED CENTERLINE ALIGNMENT IS INTENDED TO FOLLOW THE EXISTING ROADWAY CENTERLINE (AS DETERMINE BY TOPOGRAPHIC FIELD SURVEY). IN SOME INSTANCES, THE PROPOSED CENTERLINE MAY NEED TO BE FIELD ADJUSTED FOR THE BEST FIT CROSS-SECTION. IF IT IS DETERMINED THAT THE PROPOSED CENTERLINE ALIGNMENT NEEDS TO BE SHIFTED, THE CONTRACTOR SHALL NOTIFY THE ENGINEER FOR APPROVAL PRIOR TO THIS ADJUSTMENT.
- 4. ROADWAY CONSTRUCTION IS INTENDED TO MATCH EXISTING GRADES AT TIE-IN LOCATIONS. THE CONTRACTOR SHALL PROVIDE A SMOOTH TAPER AT THE TIE-INS.
- 5. THE PROPOSED ROADWAY PROFILE SHALL GENERALLY FOLLOW THE GRADE OF THE EXISTING ROADWAY EXCEPT IN THE INSTANCES WHERE MINIMUM COVER ABOVE A PROPOSED CULVERT IS CALLED OUT ON THE PLANS.

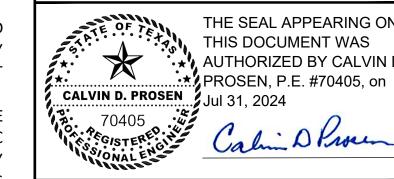

THE SEAL APPEARING ON THIS DOCUMENT WAS A AUTHORIZED BY CALVIN D. ...★.ZPROSEN, P.E. #70405, on Jul 31, 2024

By Chk. Appr. Date Revision

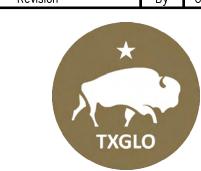

CITY OF DAISETTA, TEXAS ROAD REHABILITATION PROJECT

> **GENERAL NOTES & PROJECT NOTES**

LJA Engineering, Inc.

2615 Calder Avenue, Suite 500 Beaumont, Texas 77702

JOB NO.: B1246-1004 DESIGN: T.G. DRAWN: B.D.S. DATE: JULY 2024 SCALE: 1"=300' CHECKED: T.G. APPROVED: C.D.P. SHEET NO. 03 OF 28

Phone 409.833.336

Fax 409.833.031

FRN - F-138

			ITEM 247	ITEM 275	ITEM 275	ITEMS 300 & 310	ITEM 340	ITEM 530	ITEM 530
	ROADWAY/		FLEXIBLE BASE	PULVERIZE, RESHAPE & RECOMPACT ROADWAY	CEMENT TREATMENT (4%)	INSTALLTRACKLESS TACK AS PRIME COAT (0.1 GAL/SY)	TY-D HMAC	CONSTRUCT INTERSECTION TURNOUT (ASPH)	CONSTRUCT DRIVEWAY
	PROJECT LOCATION	STATION RANGE	(SY)	(SY)	(TON)	(GAL)	(TON)	(SY)	(SY)
BASE BID A	BOBCAT LN	STA 12+81 TO STA 26+00		2,771	44	277	410	175	151
BASE BID B	IDAHO	STA 0+10 TO STA 13+38		2,808	44	281	309	95	147
BID C (ALT BID #1)	BOBCAT LN	STA 12+81 TO STA 26+00	308	308	5	31			
BID D (ALT BID #2)	IDAHO	STA 0+10 TO STA 13+38	310	310	5	31			
BID E (ALT #3)	BOBCAT LN	STA 0+00 TO STA 12+81		2,099	33	210	231		158
BID F (ALT #4)	BOBCAT LN	STA 0+00 TO STA 12+81	299	299	5	30			
BID G (ALT #5)	BOBCAT LN	STA 26+00 TO STA 42+92		3,616	57	362	398	182	133
BID H (ALT #6)	BOBCAT LN	STA 26+00 TO STA 42+92	395	395	6	39			
BID J (ALT #7)	DAKOTA	STA 0+09 TO STA 10+90		1,873	30	187	412	79	121
BID K (ALT #8)	DAKOTA	STA 0+09 TO STA 10+90	254	254	4	25			
		TOTALS	1,566	14,732	233	1,473	1,759	530	710

THE QUANTITIES IN THE TABLE WERE CALCULATED BASED ON SURVEY DATA AND THE BASIS OF ESTIMATE NOTES BELOW. THE CONTRACTOR IS SOLELY RESPONSIBLE FOR COLLECTING AND CALCULATING THEIR OWN DATA AND QUANTITIES.

	BASIS OF ESTIMATE			
ITEM	ITEM DESCRIPTION RATE/CONVERSION BID UNIT		BID UNIT	
275	CEMENT TREATMENT	4% CEMENT	TON	
2/5	CEIVIENT TREATIVIENT	DRY WEIGHT 125 LB/CF		
310	PRIME COAT	0.10 GAL/SY	GAL	
340	TY-D HMAC	110LB/SY	TON	



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Revision By Chk. Appr. Date



CITY OF DAISETTA, TEXAS ROAD REHABILITATION PROJECT

SUMMARY OF QUANTITIES

LJA Engineering, Inc.2615 Calder Avenue, Suite 500

2615 Calder Avenue, Suite Beaumont, Texas 77702

APPROVED: C.D.P.

 FRN - F-1386


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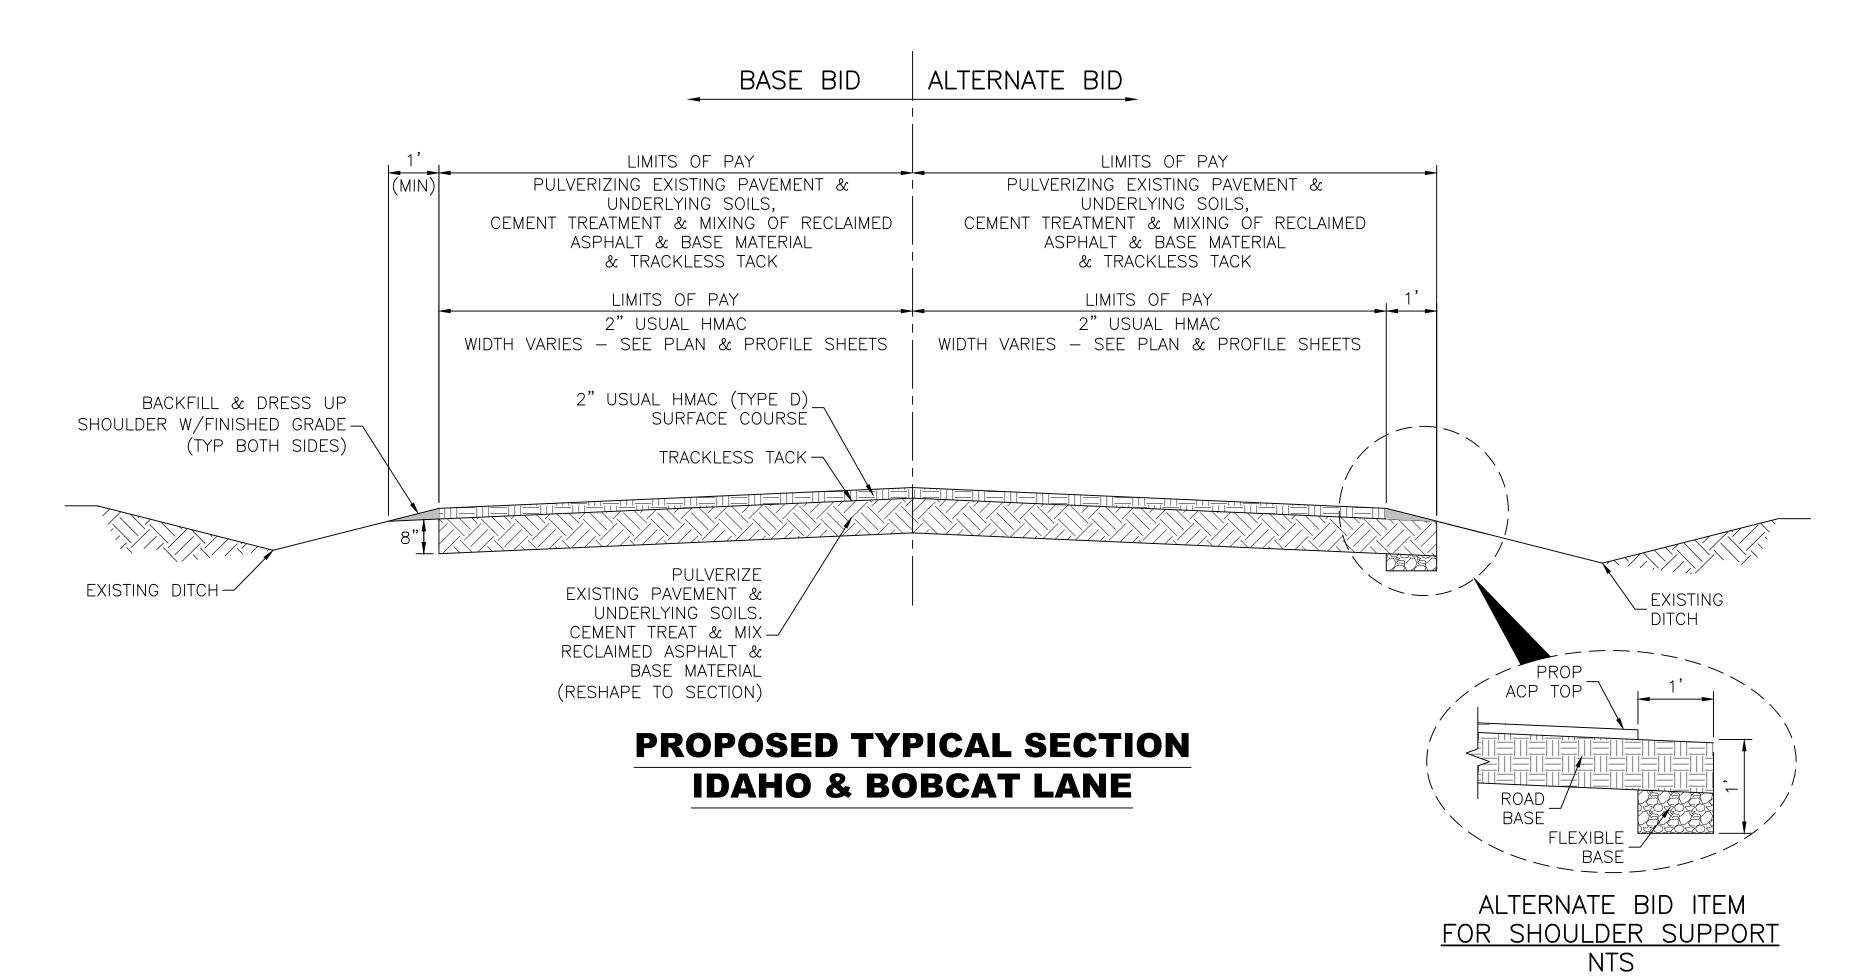
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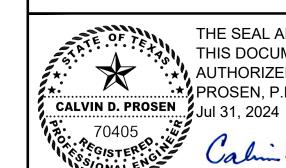
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CITY OF DAISETTA, TEXAS **ROAD REHABILITATION PROJECT**

TYPICAL SECTIONS

LJA Engineering, Inc. 2615 Calder Avenue, Suite 500

Beaumont, Texas 77702

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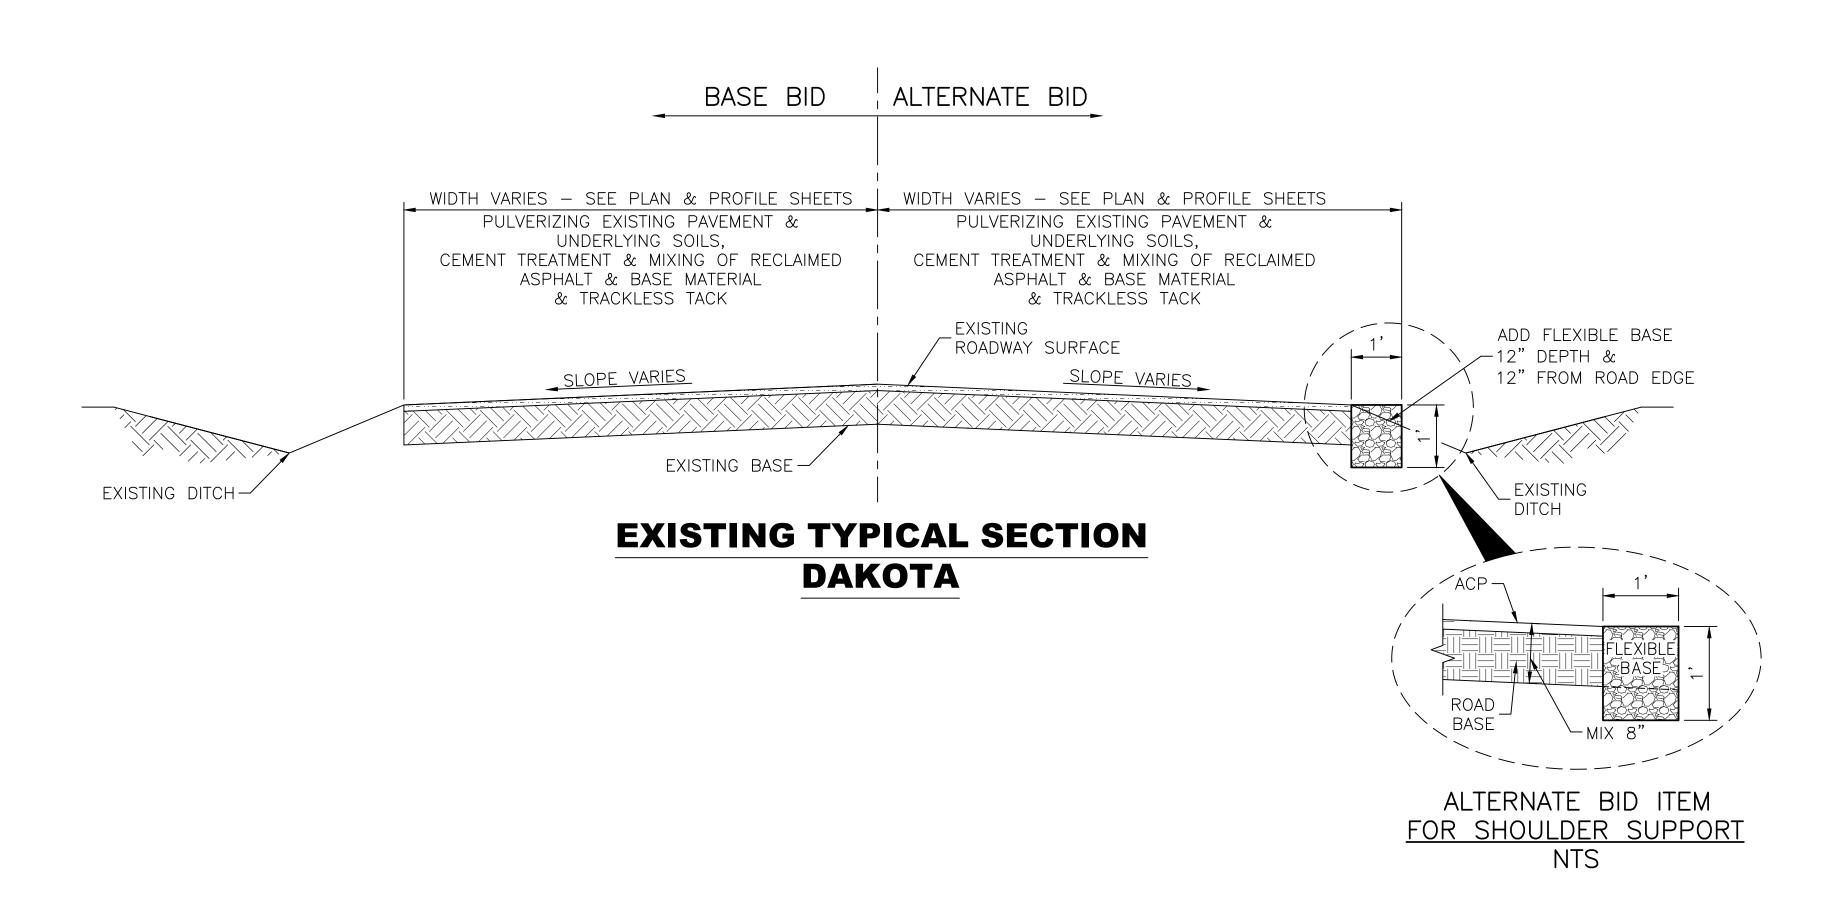
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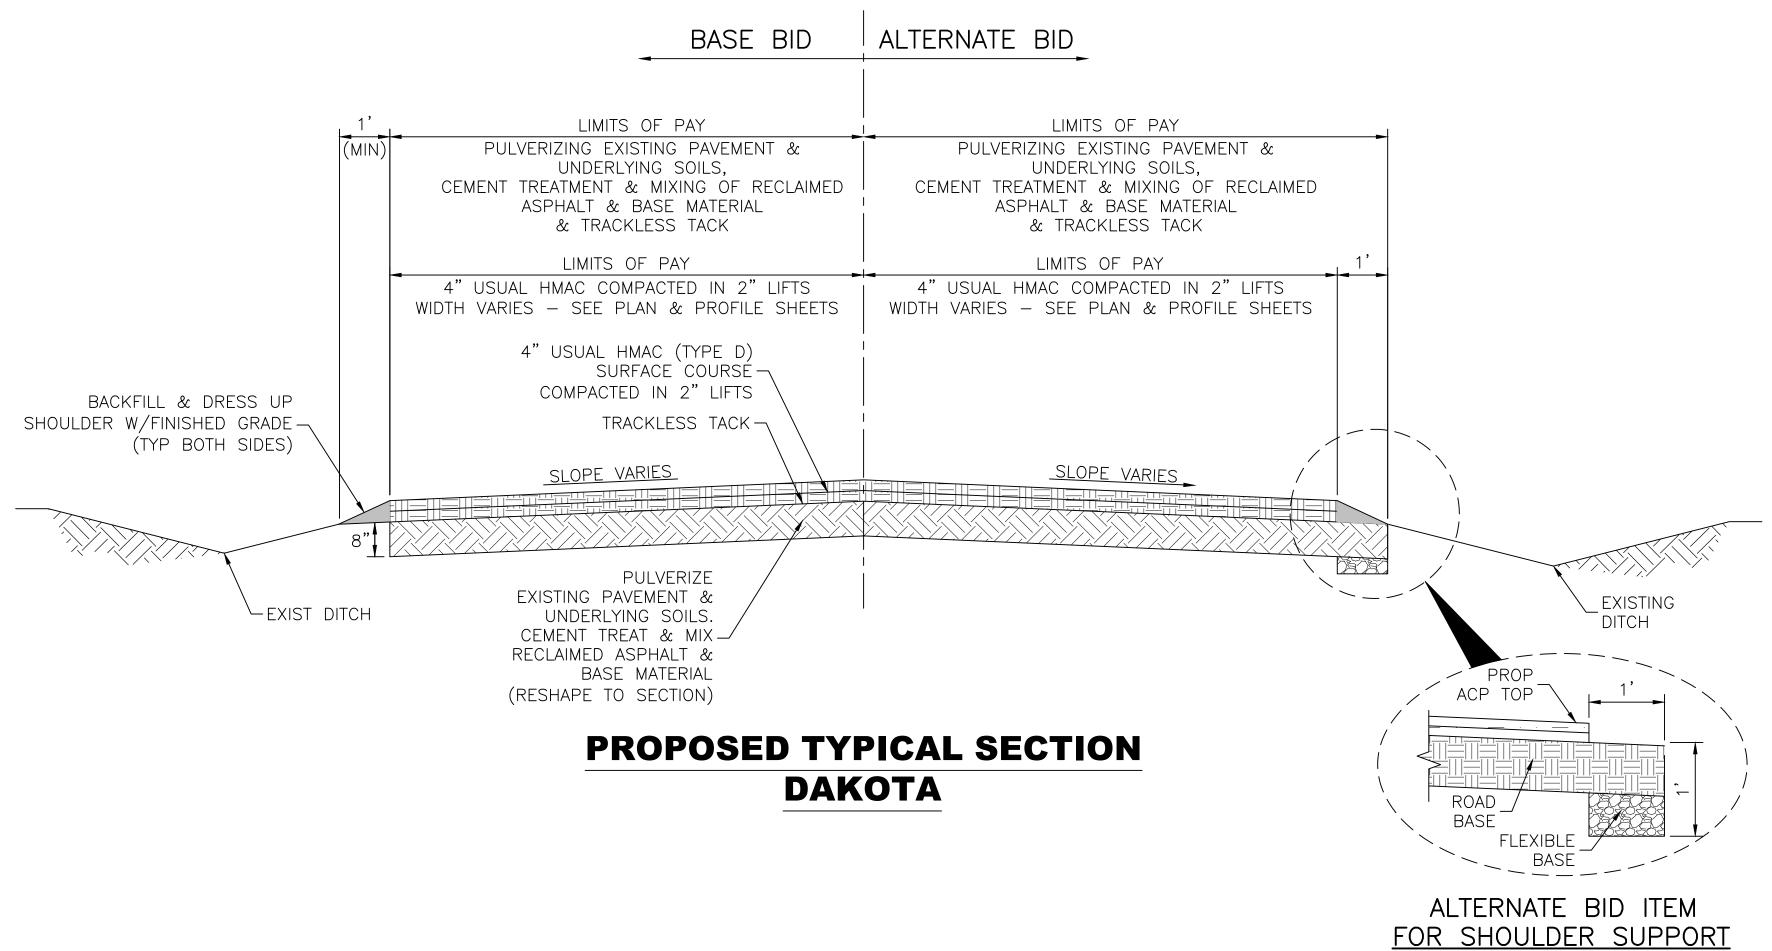
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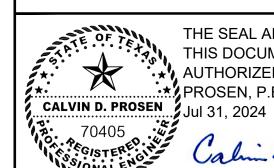
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AUTHORIZED BY CALVIN D.
PROSEN, P.E. #70405, on
Jul 31, 2024

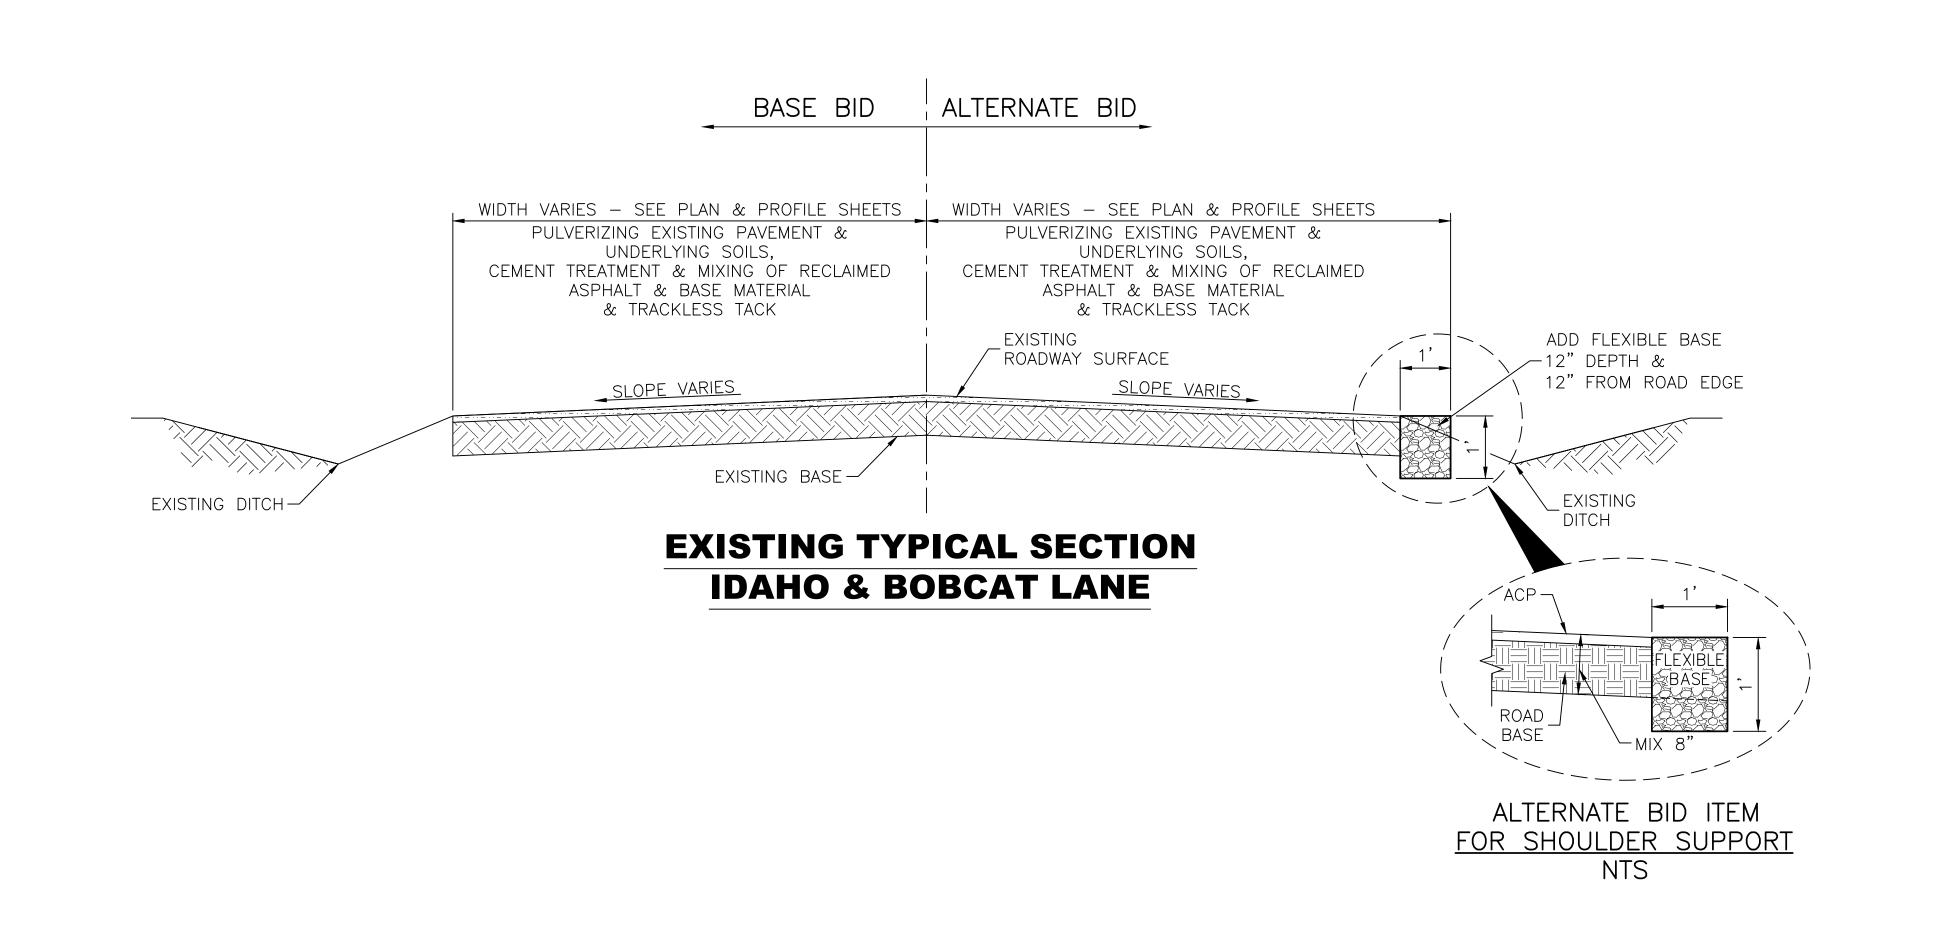Revision By Chk. Appr. Date



CITY OF DAISETTA, TEXAS
ROAD REHABILITATION PROJECT

TYPICAL SECTIONS

LJA Engineering, Inc. 2615 Calder Avenue, Suite 500

2615 Calder Avenue, Suite 5 Beaumont, Texas 77702

NTS

Fax 409.833.0317 FRN - F-1386

DESIGN: T.G.

JOB NO.: B1246-1004

DRAWN: B.D.S.


DATE: JULY 2024


CHECKED: T.G.

SCALE: N.T.S.

APPROVED: C.D.P.

SHEET NO. 05B OF 28

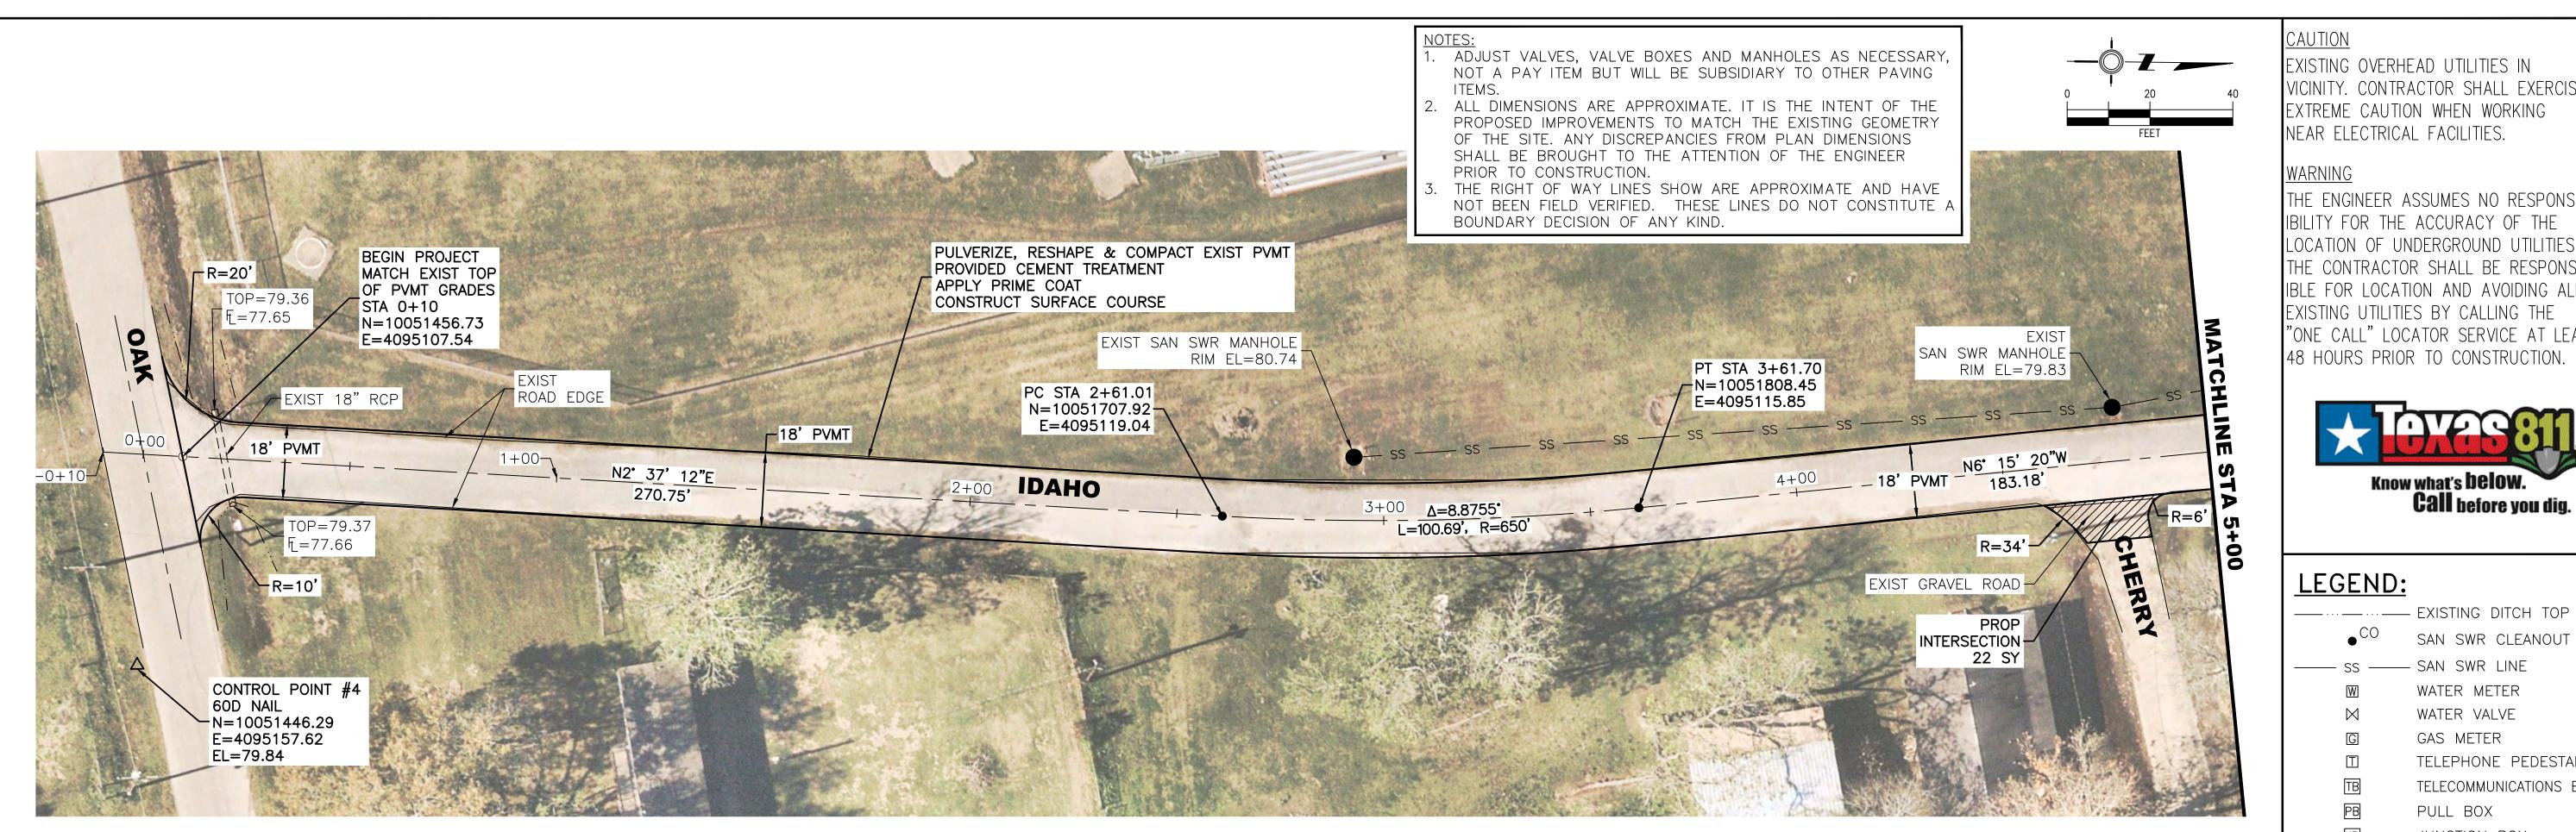

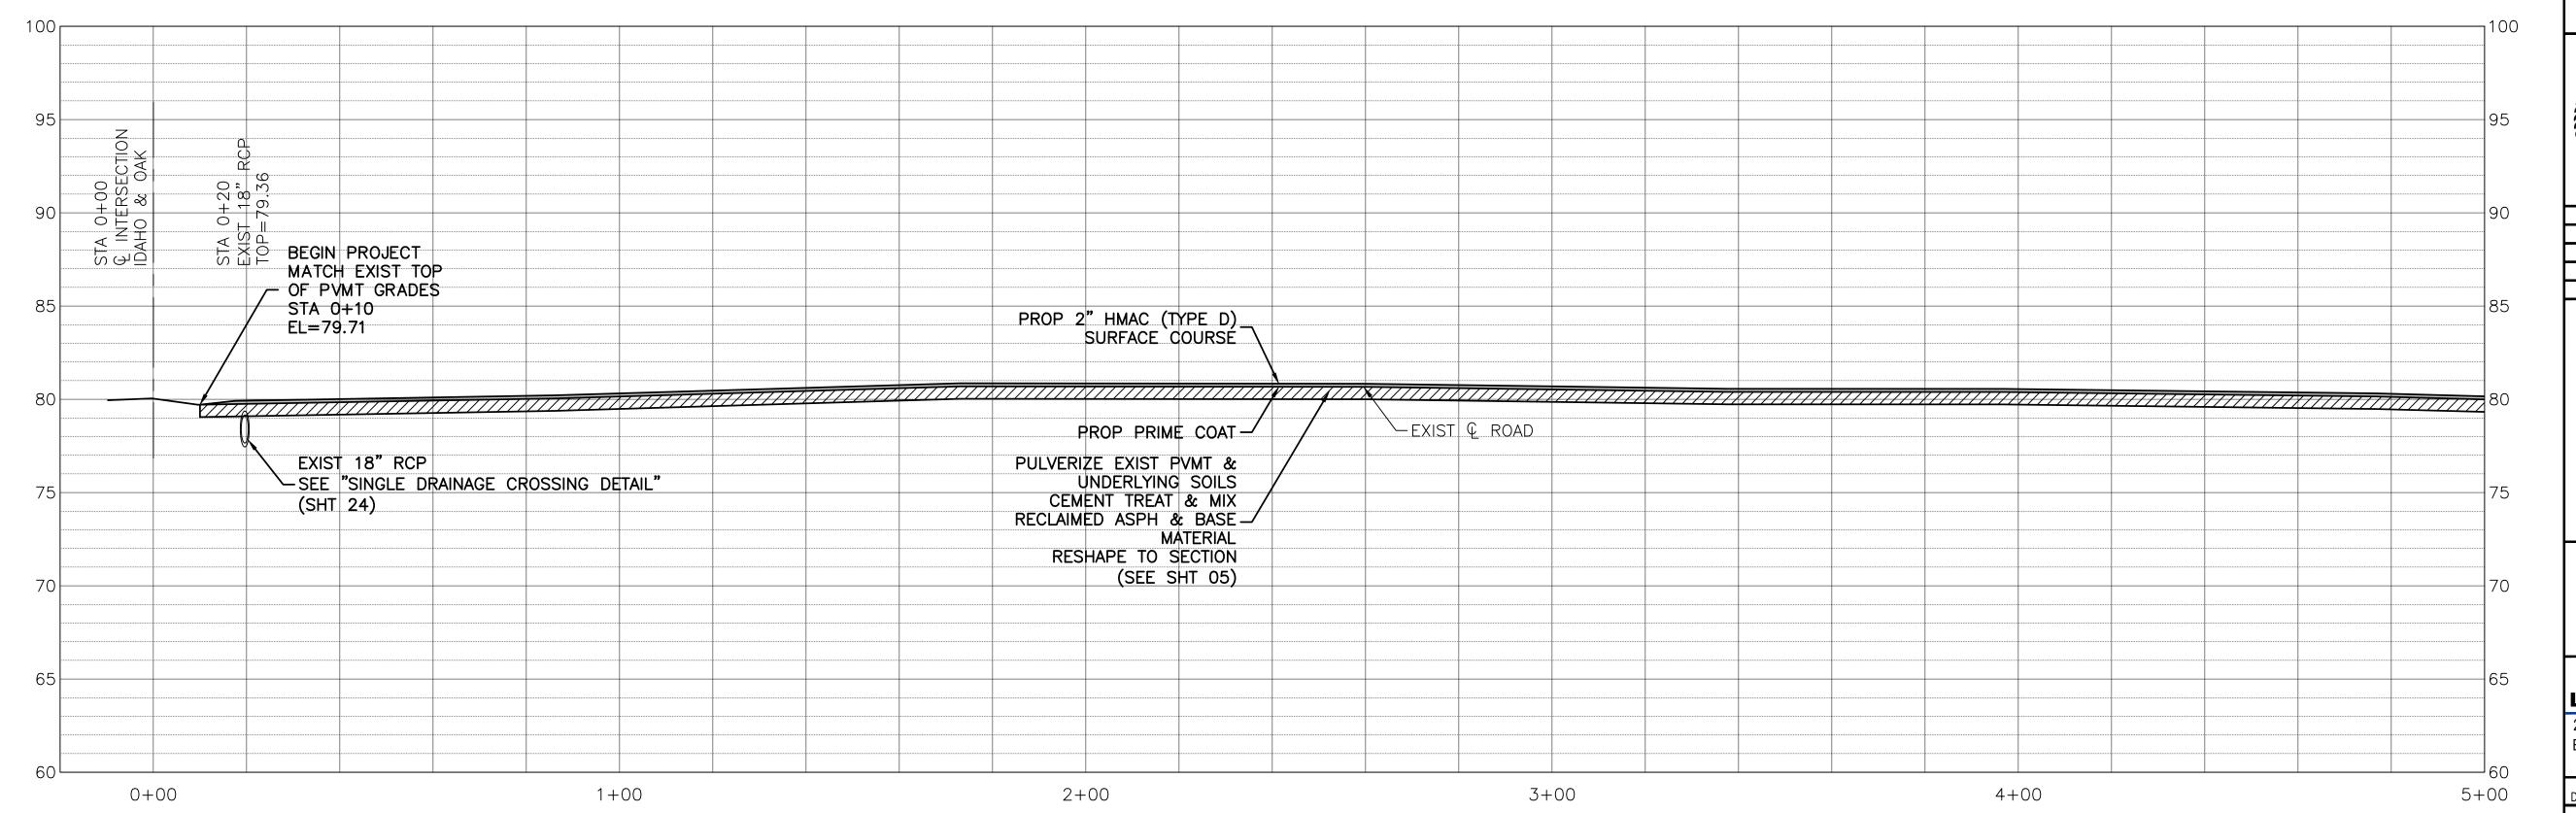

EXISTING OVERHEAD UTILITIES IN VICINITY. CONTRACTOR SHALL EXERCISE EXTREME CAUTION WHEN WORKING NEAR ELECTRICAL FACILITIES.

WARNING

THE ENGINEER ASSUMES NO RESPONS-IBILITY FOR THE ACCURACY OF THE LOCATION OF UNDERGROUND UTILITIES. THE CONTRACTOR SHALL BE RESPONS-IBLE FOR LOCATION AND AVOIDING ALL EXISTING UTILITIES BY CALLING THE "ONE CALL" LOCATOR SERVICE AT LEAST 48 HOURS PRIOR TO CONSTRUCTION.



SAN SWR CLEANOUT

LEGEND:

W	WATER METER
\bowtie	WATER VALVE
G	GAS METER
	TELEPHONE PEDESTA
TB	TELECOMMUNICATIONS
PB	PULL BOX
JB	JUNCTION BOX

- w ---- WATER LINE

— SS — SAN SWR LINE



 $\overline{}$

THIS DOCUMENT WAS AUTHORIZED BY CALVIN D.

By Chk. Appr. Date Revision




CITY OF DAISETTA, TEXAS **ROAD REHABILITATION PROJECT**

> **IDAHO** STA 0+00 - STA 5+00

LJA Engineering, Inc. 2615 Calder Avenue, Suite 500 Beaumont, Texas 77702

Fax 409.833.031 FRN - F-138

DESIGN: T.G.	JOB NO.: B1246-1004
DRAWN: B.D.S.	DATE: JULY 2024
CHECKED: T.G.	SCALE: HOR.:1"=20', VERT.:1"=5'
APPROVED: C D P	SHEET NO. 06 OF 28

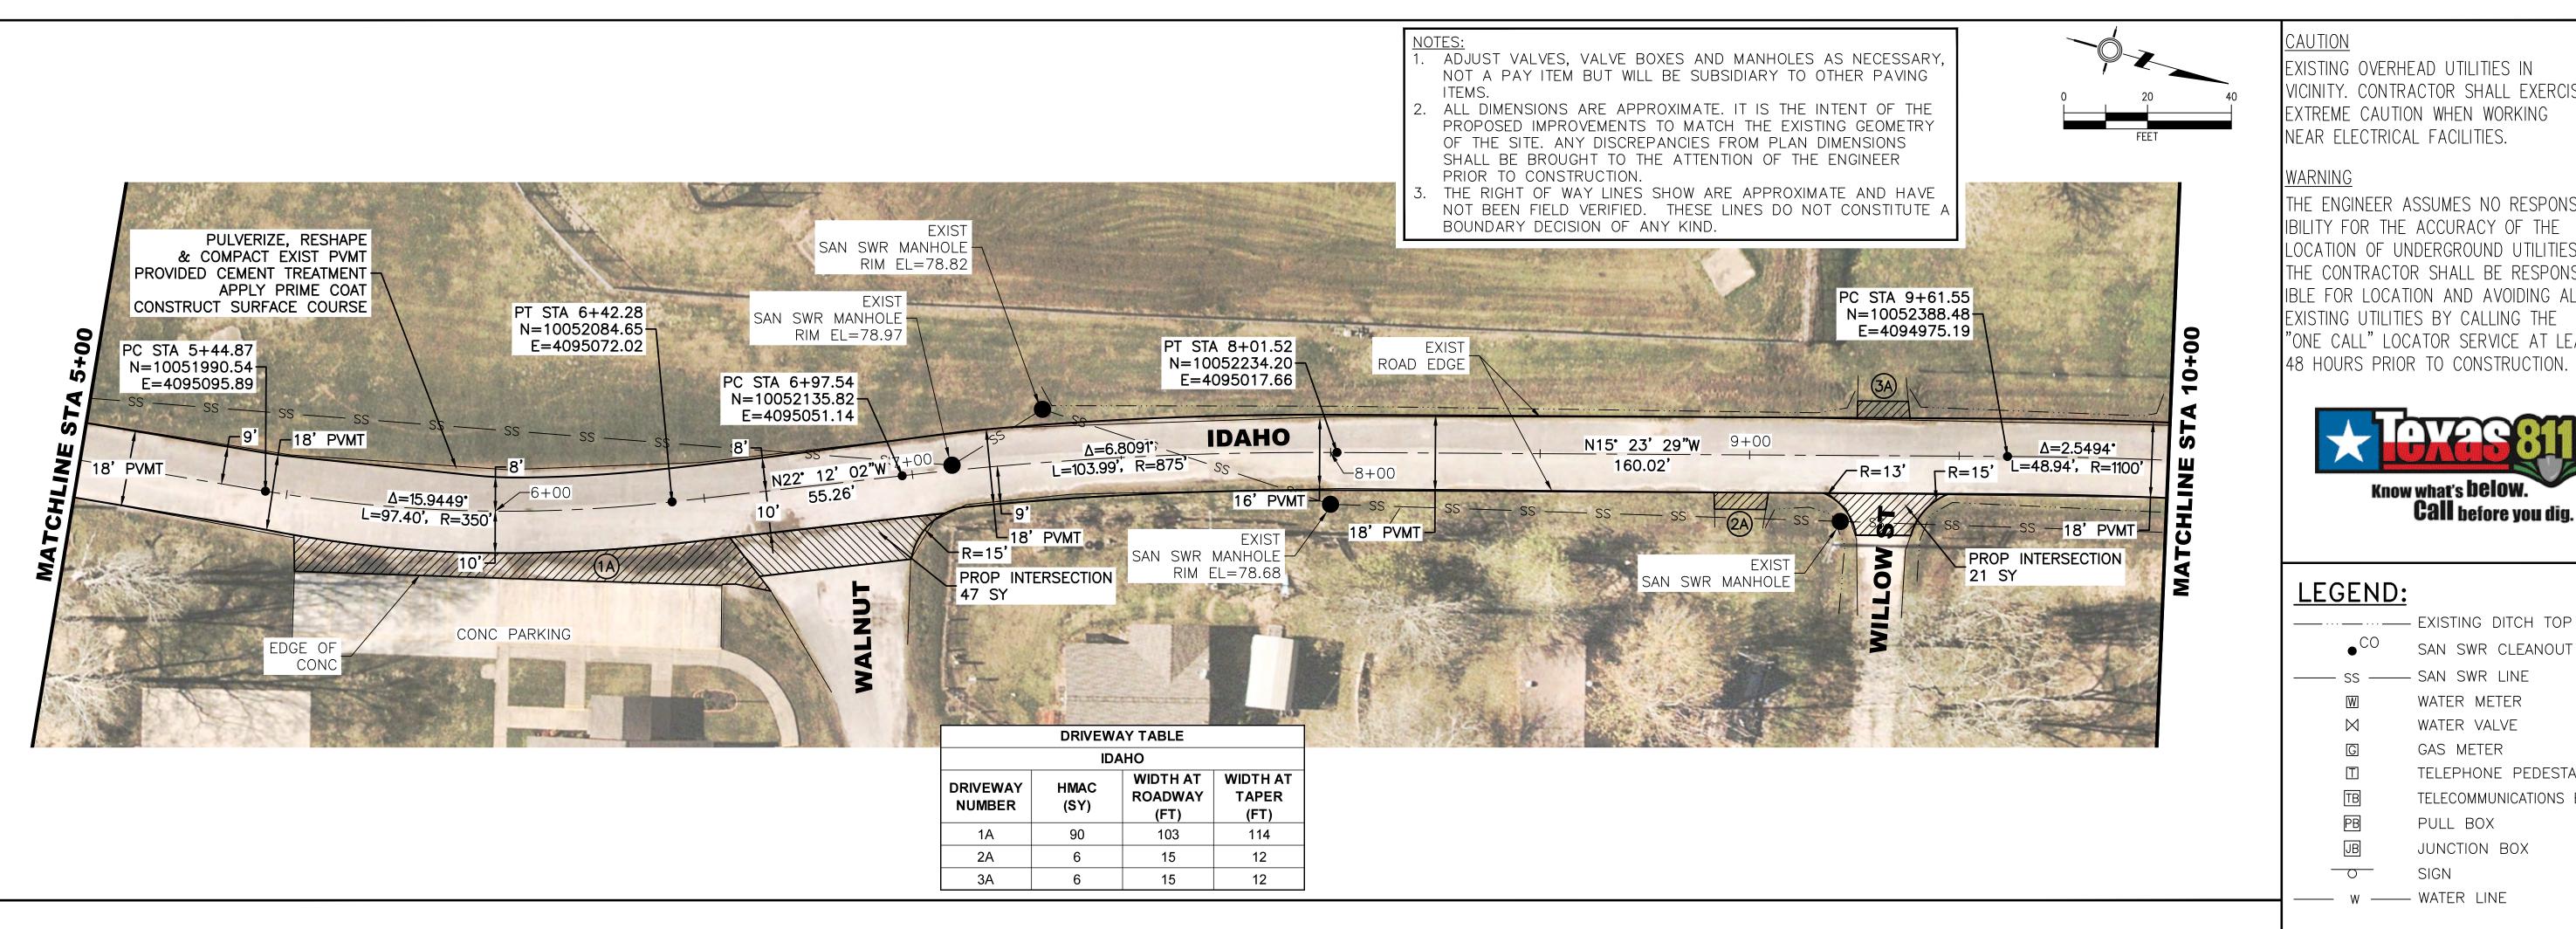



EXISTING OVERHEAD UTILITIES IN VICINITY. CONTRACTOR SHALL EXERCISE EXTREME CAUTION WHEN WORKING NEAR ELECTRICAL FACILITIES.

WARNING

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LEGEND:

● CO	SAN SWR CLEANOUT
ss	- SAN SWR LINE
W	WATER METER
\bowtie	WATER VALVE
G	GAS METER
	TELEPHONE PEDESTAL
TB	TELECOMMUNICATIONS BOX
PB	PULL BOX
JB	JUNCTION BOX
	SIGN



THE SEAL APPEARING ON THIS DOCUMENT WAS AUTHORIZED BY CALVIN D. PROSEN, P.E. #70405, on

By Chk. Appr. Date Revision



CITY OF DAISETTA, TEXAS **ROAD REHABILITATION PROJECT**


> **IDAHO** STA 5+00 - STA 10+00


LJA Engineering, Inc. 2615 Calder Avenue, Suite 500

Beaumont, Texas 77702

Phone 409.833.336 Fax 409.833.031 FRN - F-138

DESIGN: T.G.	JOB NO.: B1246-1004
DRAWN: B.D.S.	DATE: JULY 2024
CHECKED: T.G.	SCALE: HOR.:1"=20', VERT.:1"=5'
APPROVED: C.D.P.	SHEET NO. 07 OF 28

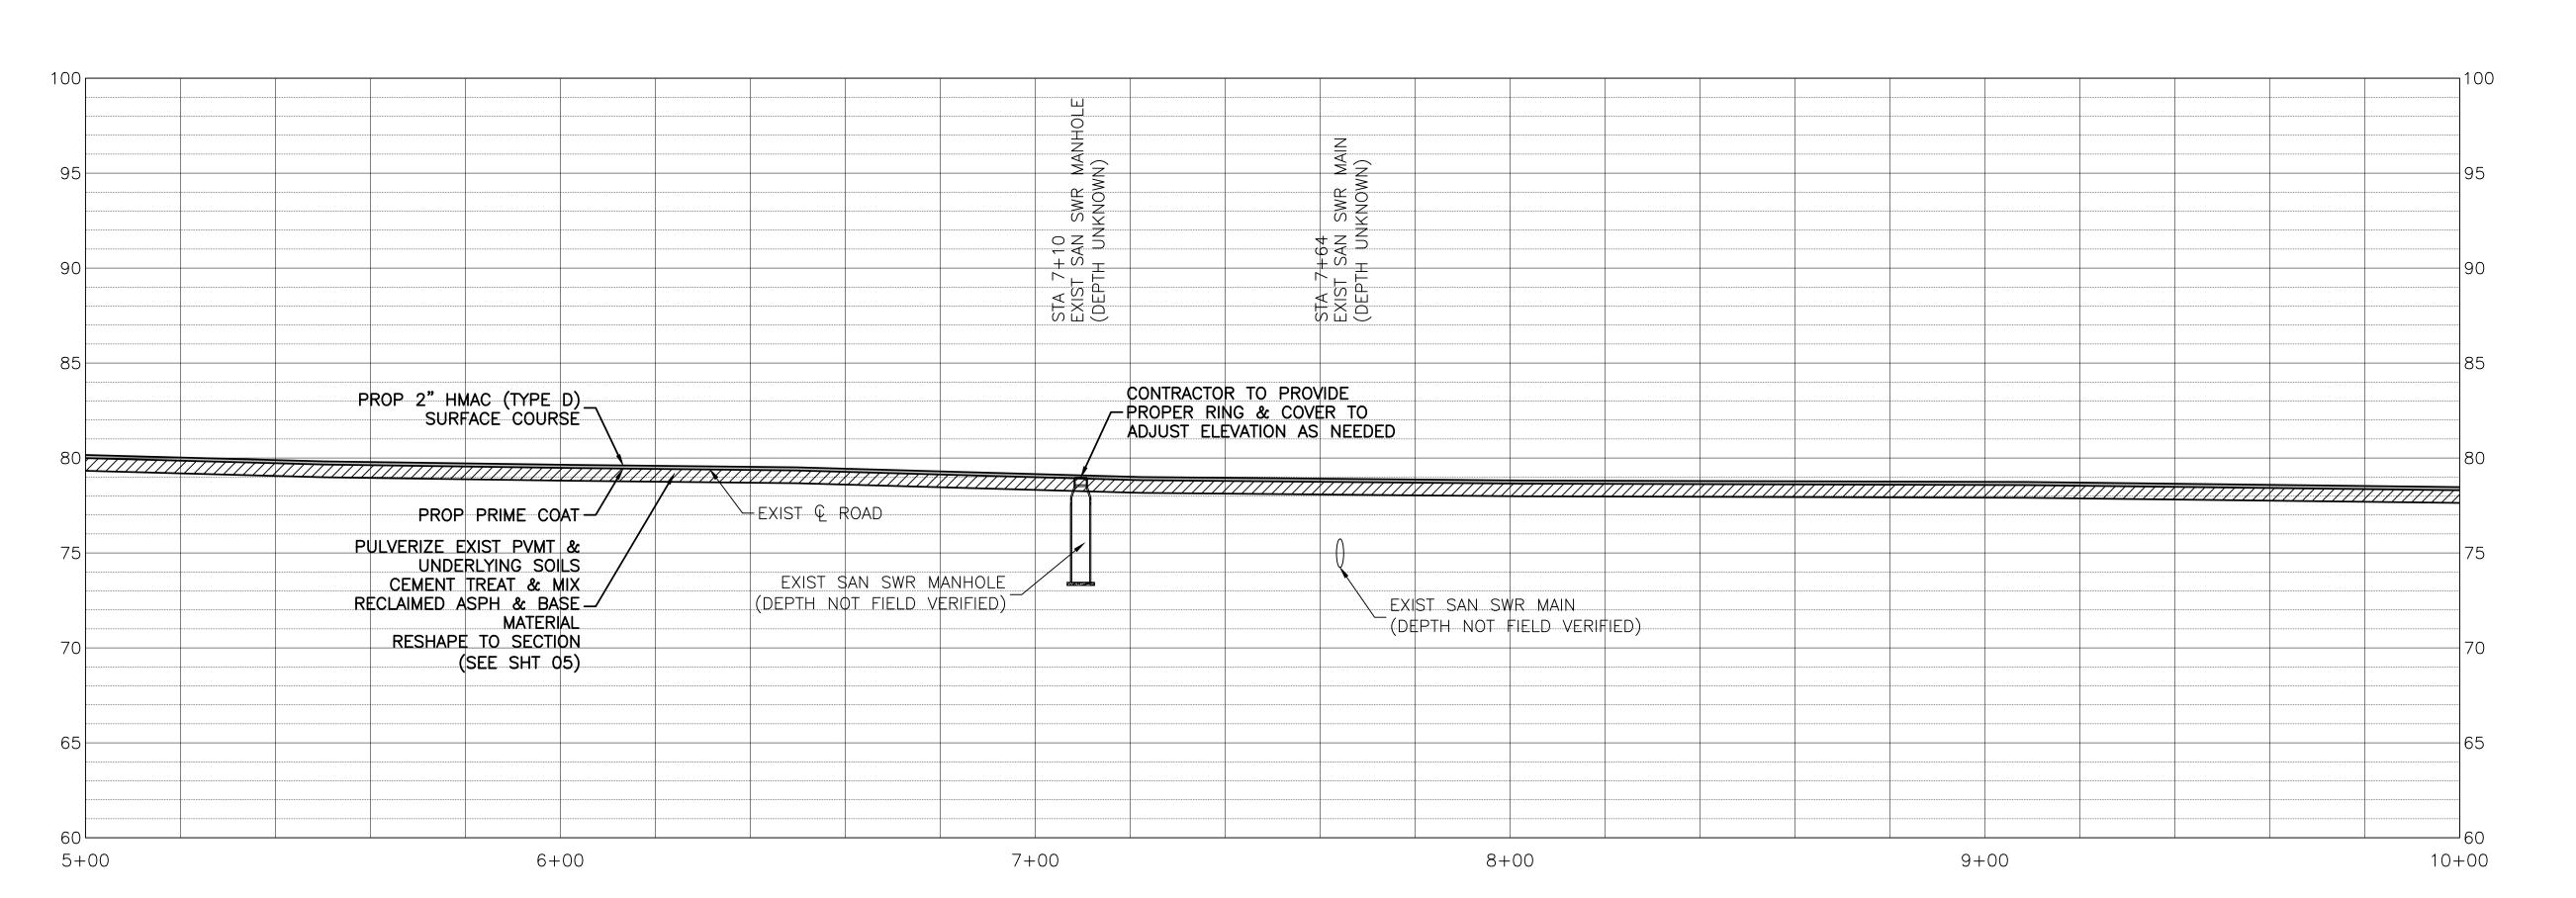

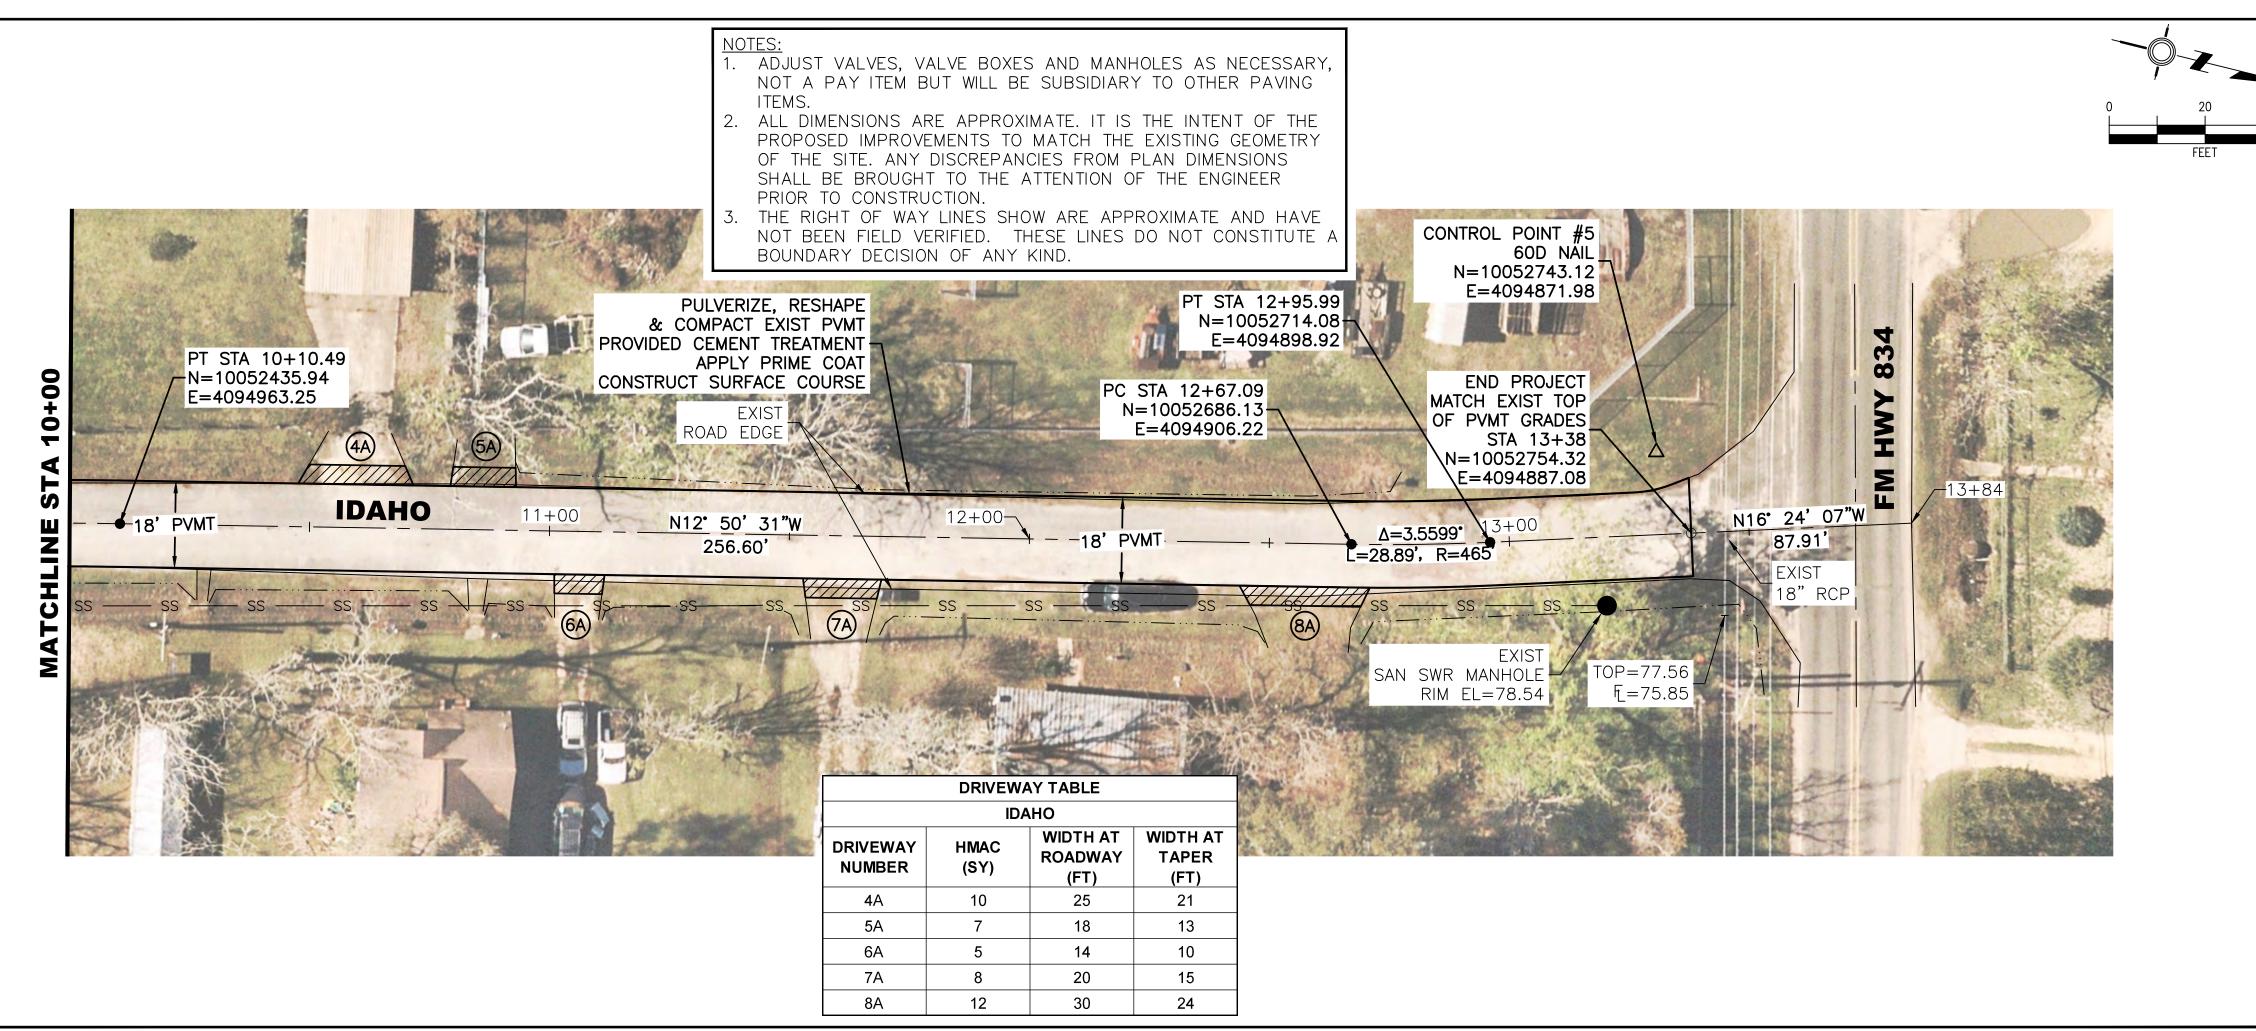



<u>CAUTION</u> EXISTING OVERHEAD UTILITIES IN VICINITY. CONTRACTOR SHALL EXERCISE EXTREME CAUTION WHEN WORKING

NEAR ELECTRICAL FACILITIES.

WARNING

THE ENGINEER ASSUMES NO RESPONS-IBILITY FOR THE ACCURACY OF THE LOCATION OF UNDERGROUND UTILITIES. THE CONTRACTOR SHALL BE RESPONS-IBLE FOR LOCATION AND AVOIDING ALL EXISTING UTILITIES BY CALLING THE "ONE CALL" LOCATOR SERVICE AT LEAST 48 HOURS PRIOR TO CONSTRUCTION.



——···— EXISTING DITCH TOP

LEGEND:

CO


● ^{CO}	SAN SWR CLEANOUT
ss	- SAN SWR LINE
W	WATER METER
\bowtie	WATER VALVE
G	GAS METER
	TELEPHONE PEDESTAL
TB	TELECOMMUNICATIONS BOX
PB	PULL BOX
JB	JUNCTION BOX
	SIGN

---- W ----- WATER LINE



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By Chk. Appr. Date

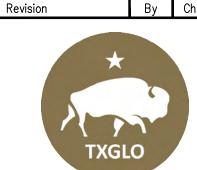

CITY OF DAISETTA, TEXAS **ROAD REHABILITATION PROJECT**

> **IDAHO** STA 10+00 - STA 13+84


LJA Engineering, Inc. 2615 Calder Avenue, Suite 500


Beaumont, Texas 77702

DESIGN: T.G.	JOB NO.: B1246-1004
DRAWN: B.D.S.	DATE: JULY 2024
CHECKED: T.G.	SCALE: HOR.:1"=20', VERT.:1"=5'
APPROVED: C.D.P.	SHEET NO. 08 OF 28

Fax 409.833.031

FRN - F-1386

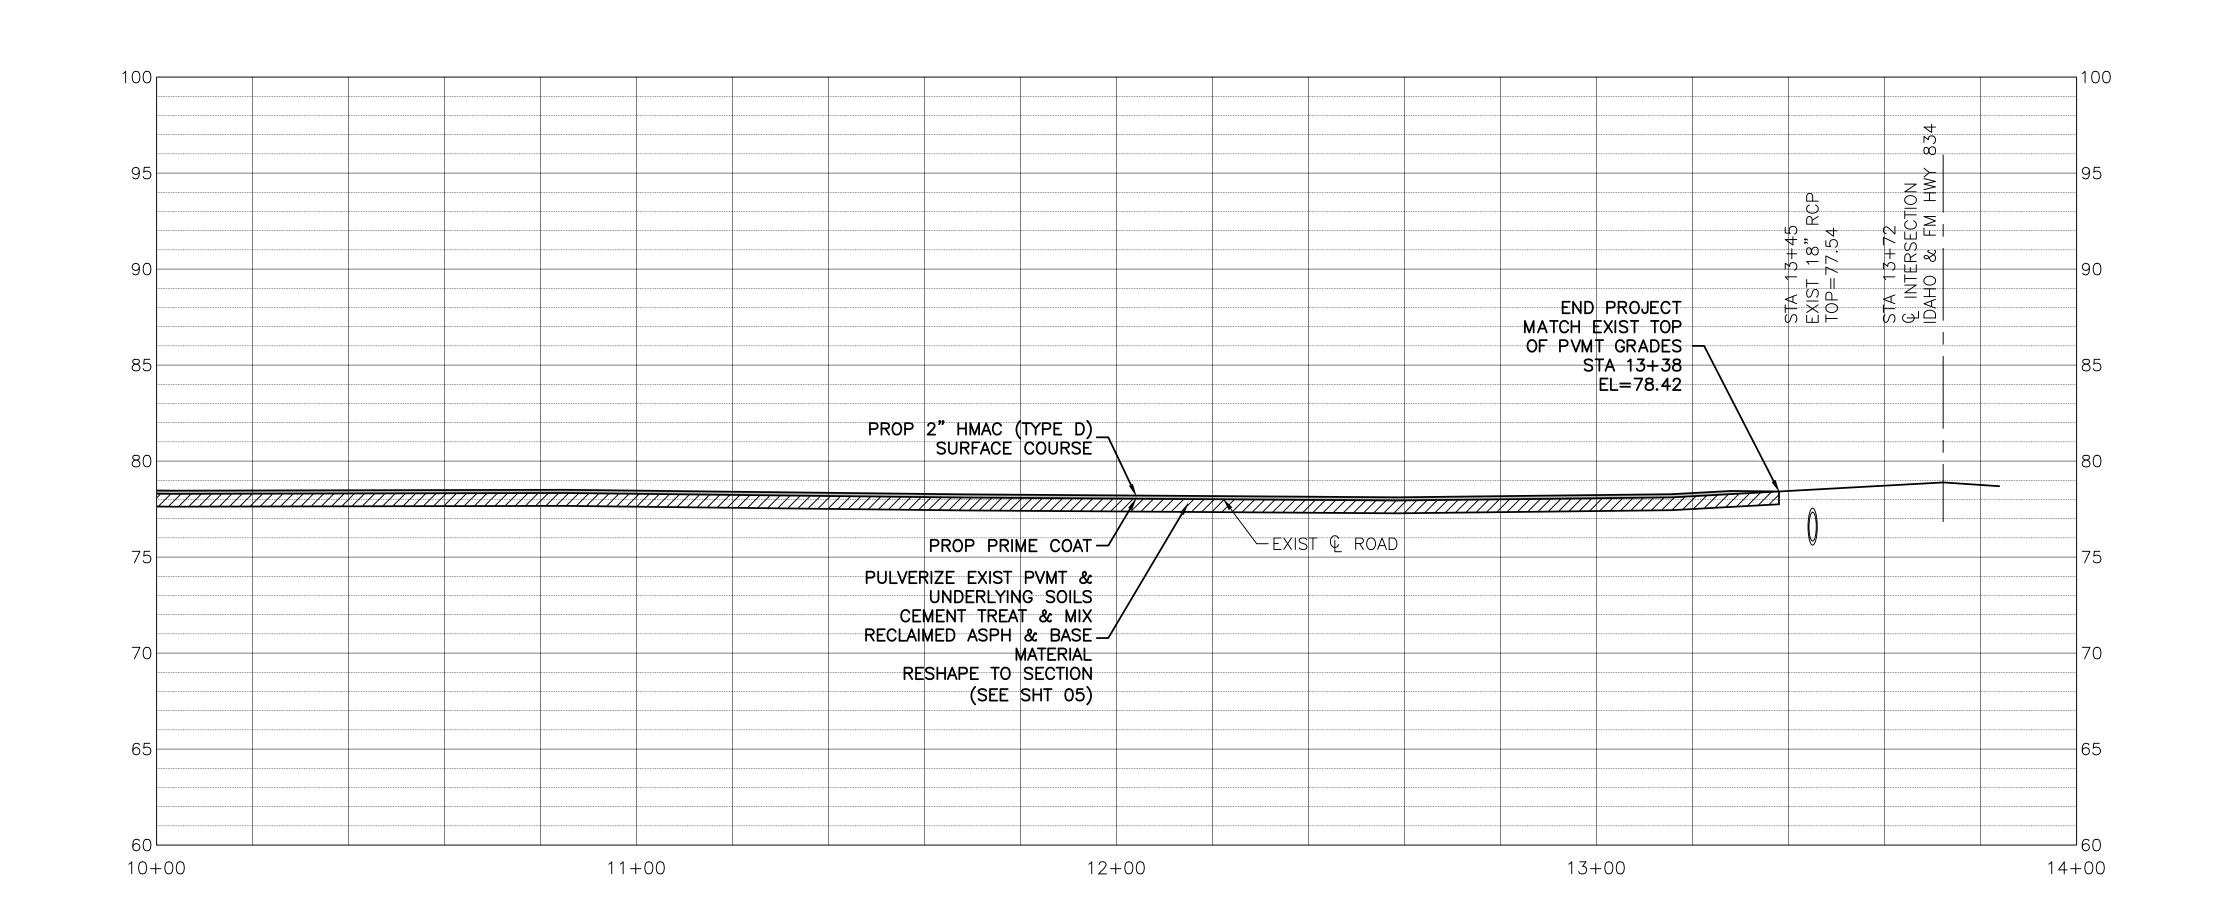

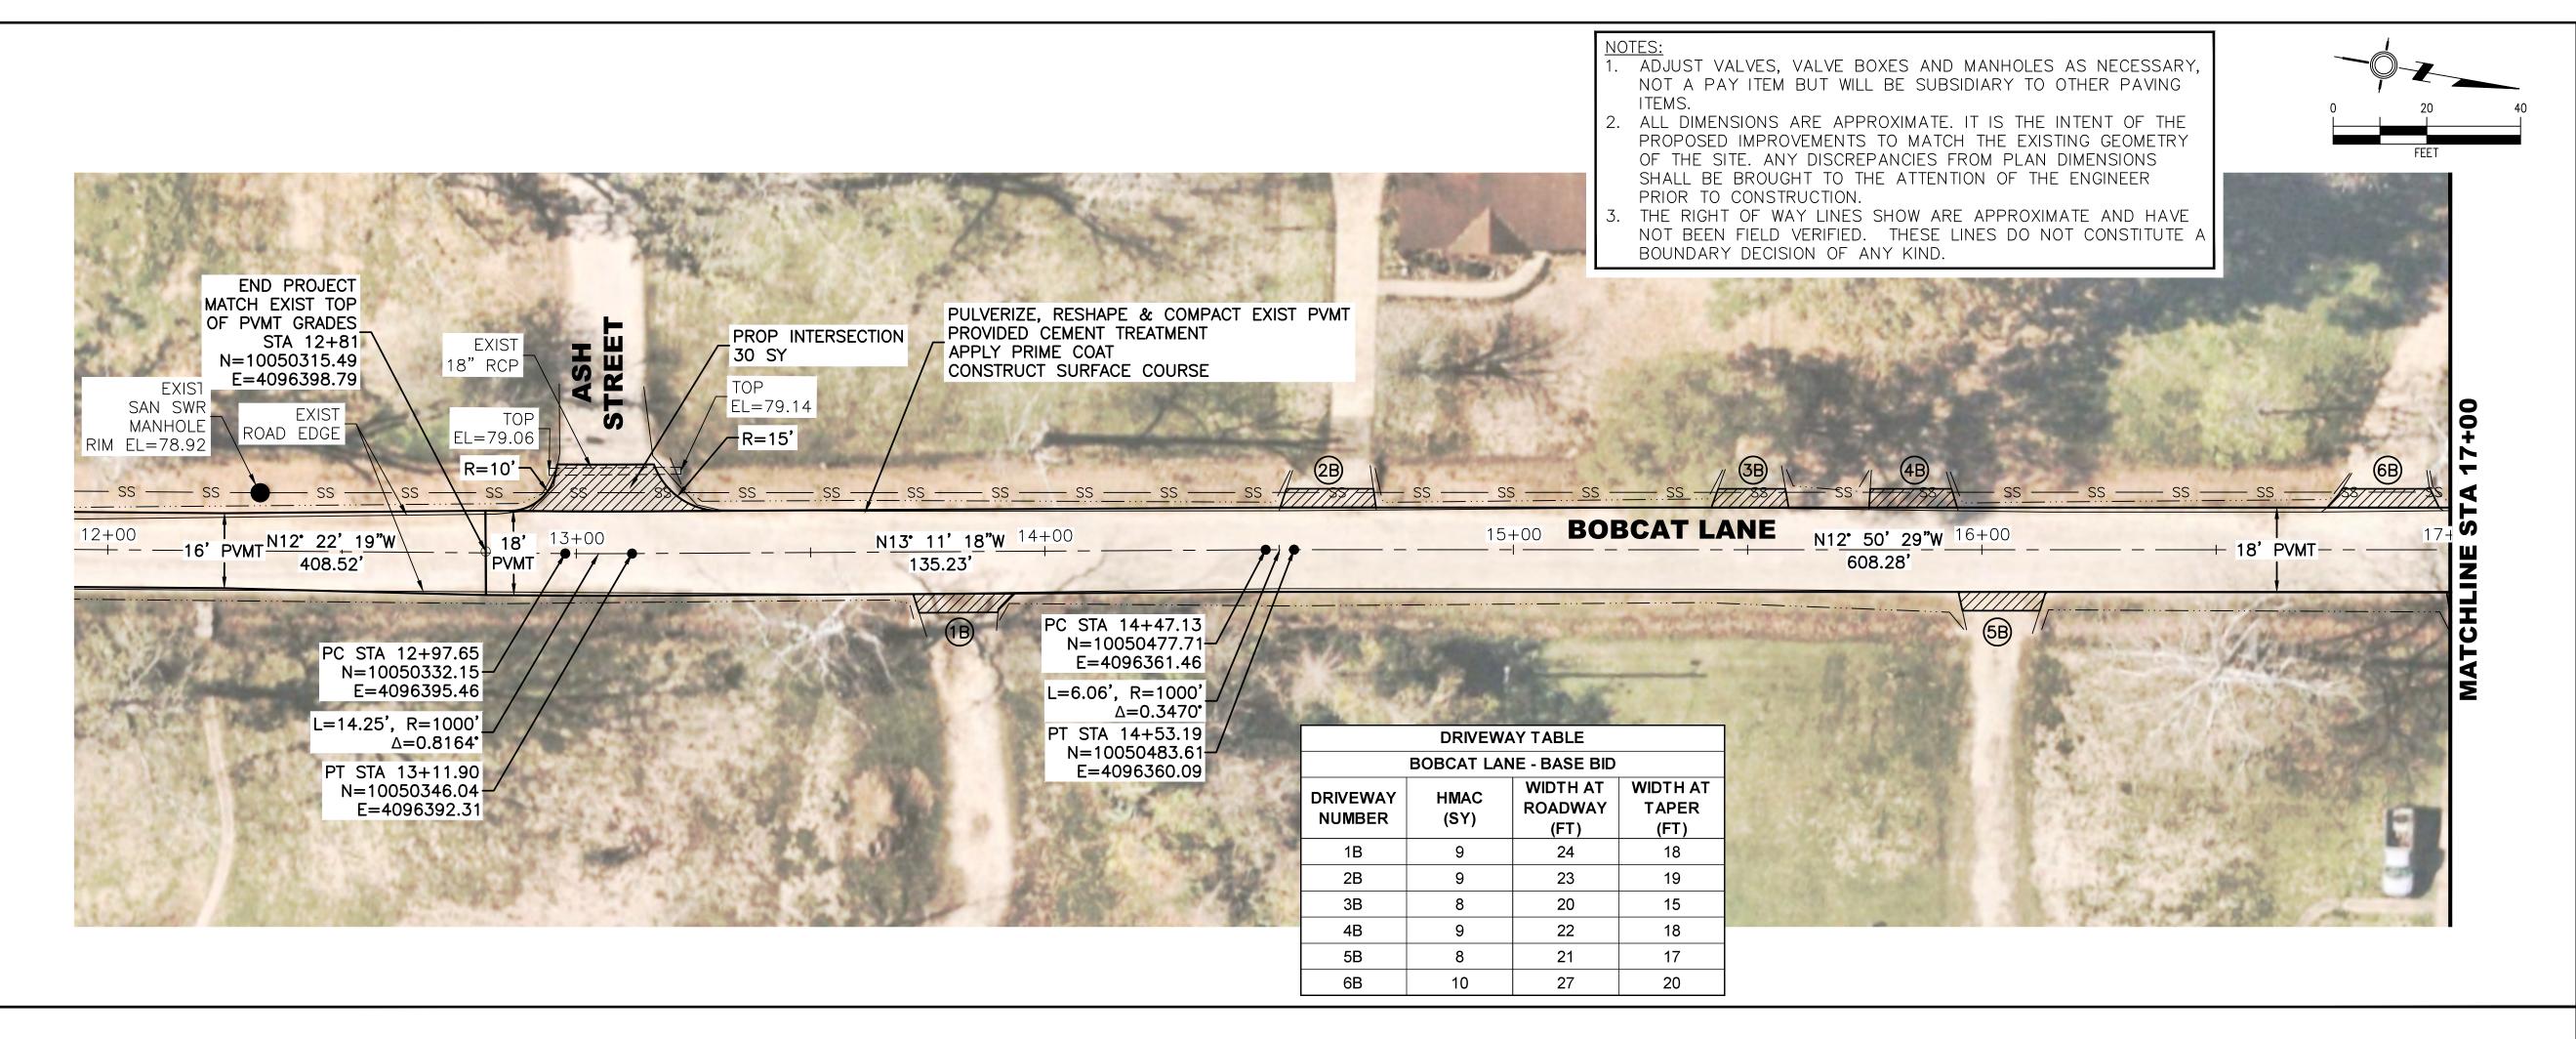

CAUTION

EXISTING OVERHEAD UTILITIES IN VICINITY. CONTRACTOR SHALL EXERCISE EXTREME CAUTION WHEN WORKING NEAR ELECTRICAL FACILITIES.

WARNING

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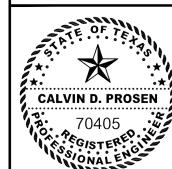


LEGEND:

• 0	SAN SWR CLEANOU
—— ss ——	SAN SWR LINE
W	WATER METER
\bowtie	WATER VALVE
G	GAS METER
	TELEPHONE PEDEST
TB	TELECOMMUNICATIONS
PB	PULL BOX
JB	JUNCTION BOX
	SIGN
	●

--- W ----- WATER LINE

------ EXISTING DITCH TOP



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By Chk. Appr. Date Revision



CITY OF DAISETTA, TEXAS **ROAD REHABILITATION PROJECT**

BOBCAT LANE BASE BID STA 12+00 - STA 17+00


LJA Engineering, Inc. 2615 Calder Avenue, Suite 500


Beaumont, Texas 77702

DESIGN: T.G. JOB NO.: B1246-1004 DATE: JULY 2024 DRAWN: B.D.S. CHECKED: T.G. SCALE: HOR.: 1"=20', VERT.: 1"=5' APPROVED: C.D.P. SHEET NO. 09 OF 28

Fax 409.833.031

FRN - F-138

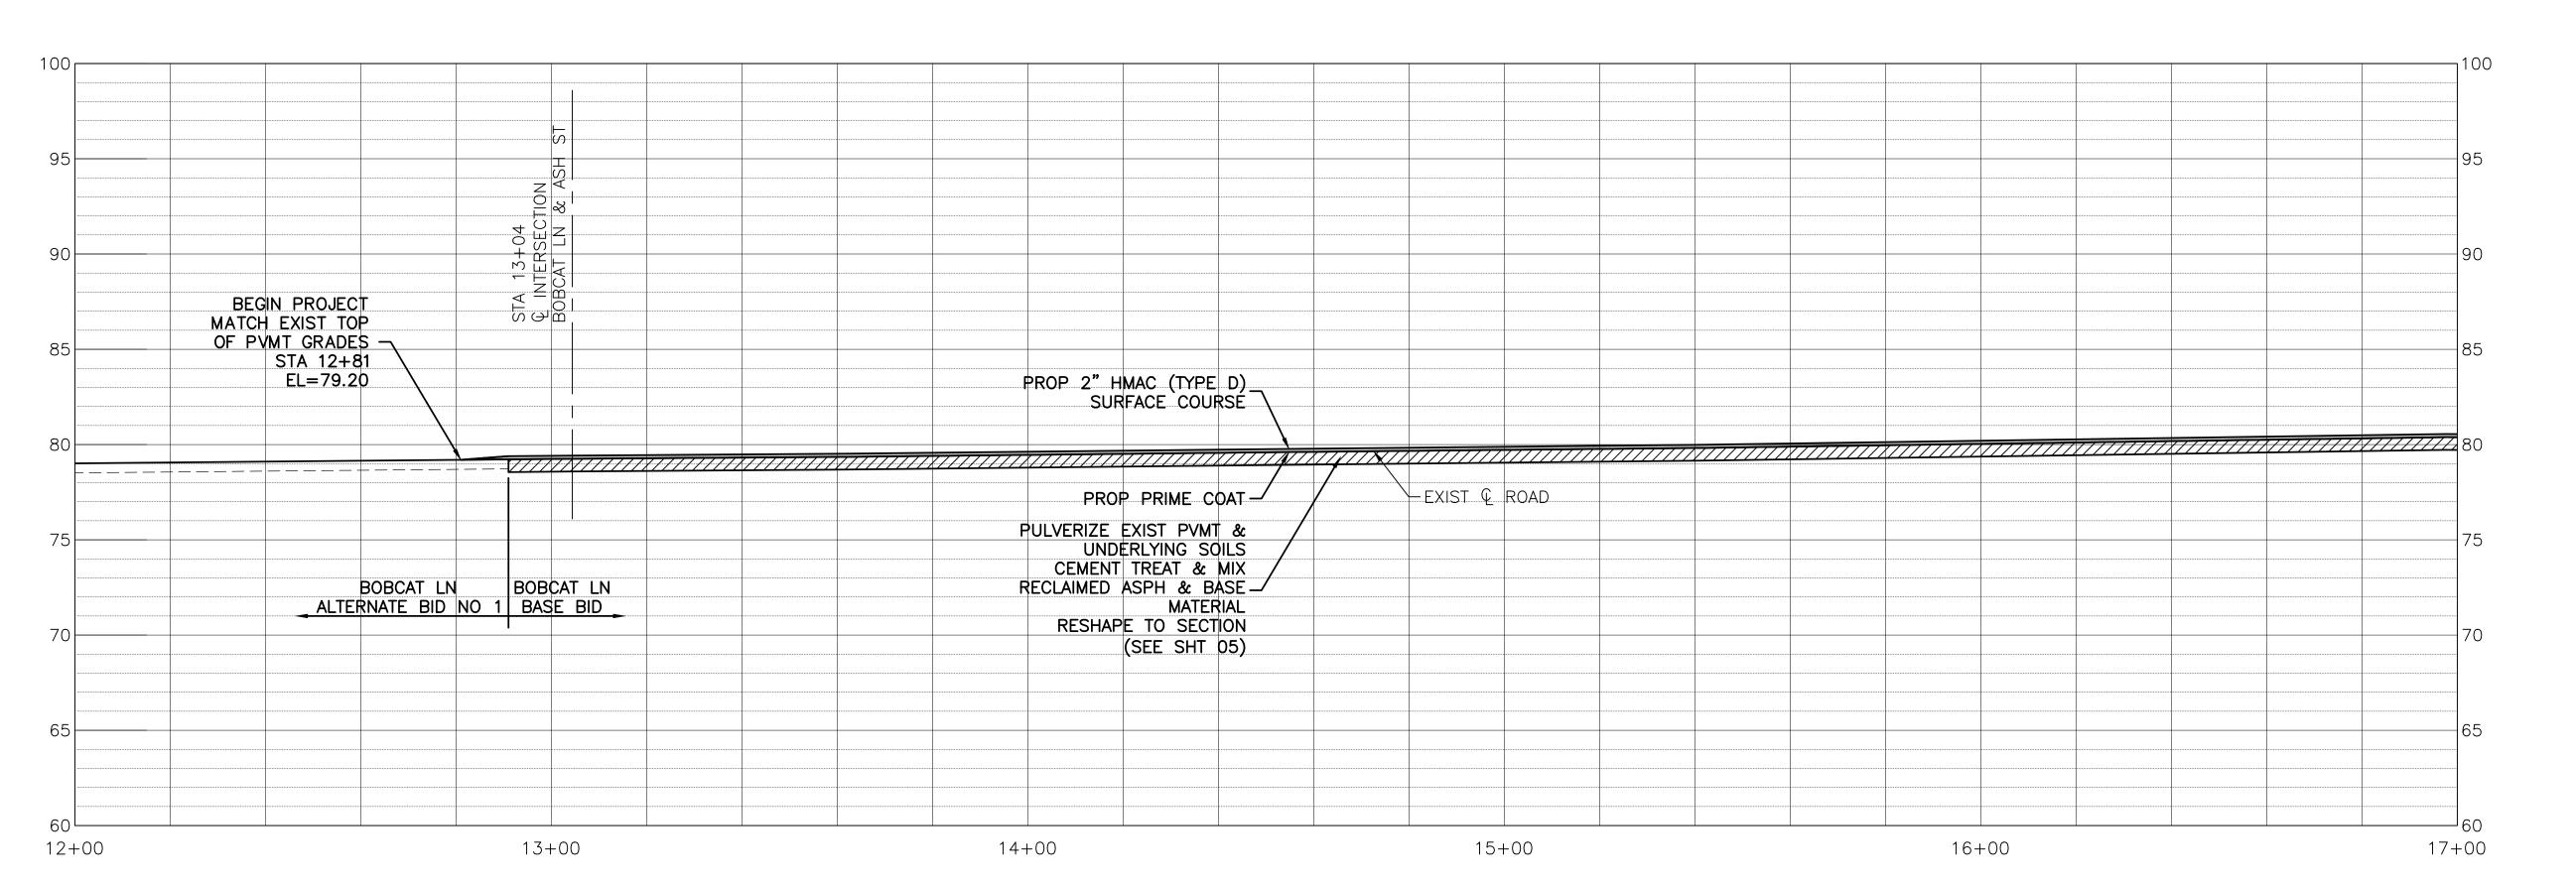

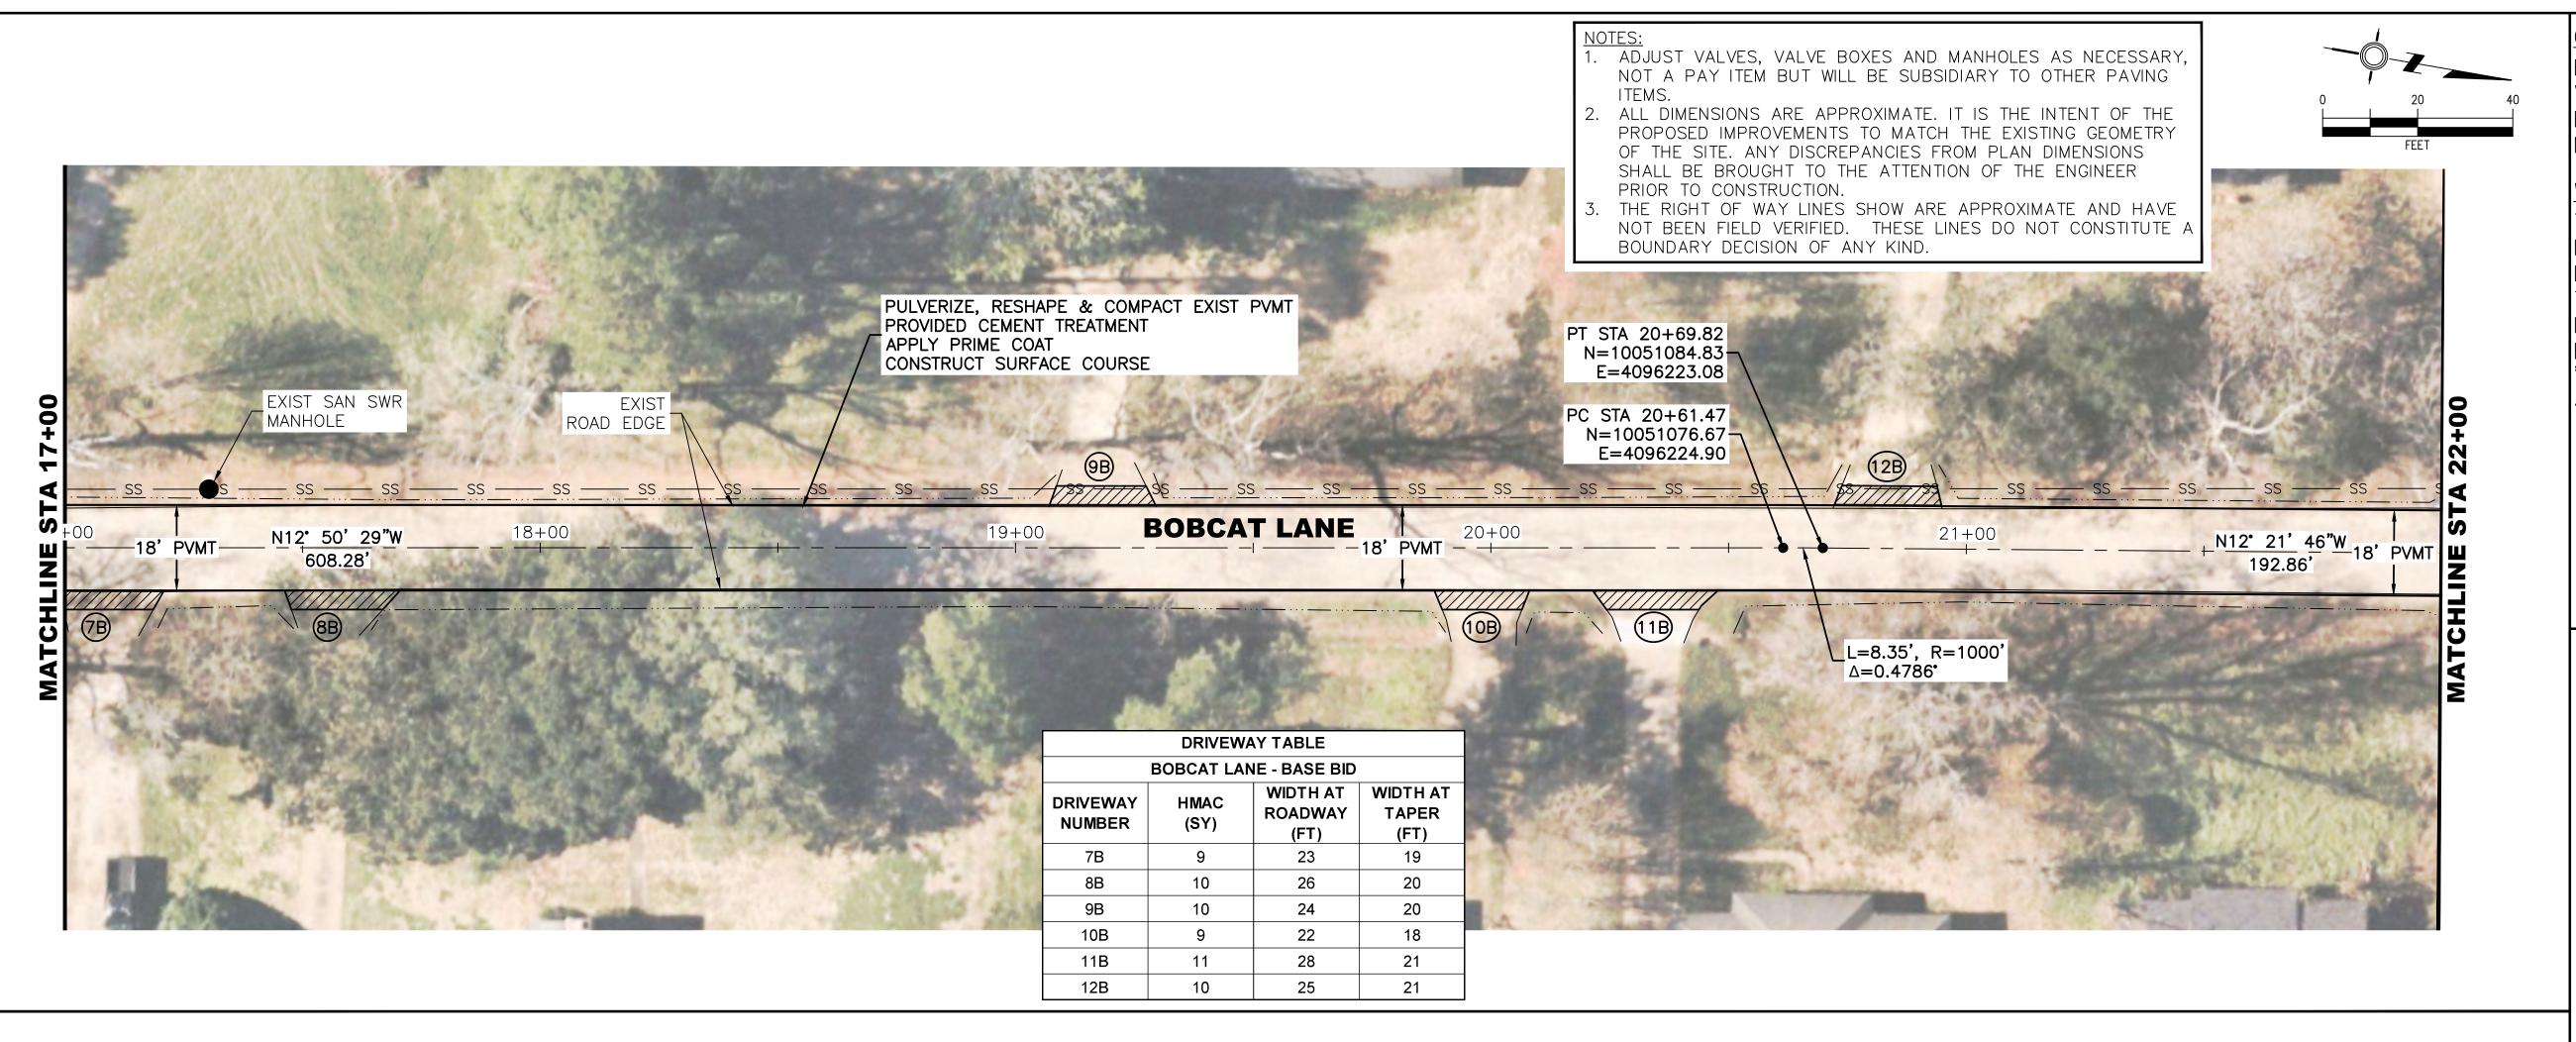



EXISTING OVERHEAD UTILITIES IN VICINITY. CONTRACTOR SHALL EXERCISE EXTREME CAUTION WHEN WORKING NEAR ELECTRICAL FACILITIES.

WARNING

THE ENGINEER ASSUMES NO RESPONS—IBILITY FOR THE ACCURACY OF THE LOCATION OF UNDERGROUND UTILITIES. THE CONTRACTOR SHALL BE RESPONS—IBLE FOR LOCATION AND AVOIDING ALL EXISTING UTILITIES BY CALLING THE "ONE CALL" LOCATOR SERVICE AT LEAST 48 HOURS PRIOR TO CONSTRUCTION.




------ EXISTING DITCH TOP

LEGEND:


● ^{CO}	SAN SWR CLEANOU
—— ss ——	SAN SWR LINE
W	WATER METER
\bowtie	WATER VALVE
G	GAS METER
	TELEPHONE PEDEST
TB	TELECOMMUNICATIONS
PB	PULL BOX
JB	JUNCTION BOX
	SIGN

---- w ----- WATER LINE

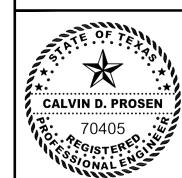

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Revision By Chk. Appr. Date

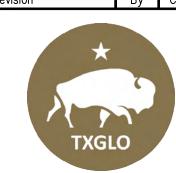


CITY OF DAISETTA, TEXAS ROAD REHABILITATION PROJECT


BOBCAT LANE BASE BID STA 17+00 - STA 22+00

LJA Engineering, Inc.
2615 Calder Avenue, Suite 500
Beaumont, Texas 77702

Fax 409.833.0317 FRN - F-1386

DESIGN: T.G.	JOB NO.: B1246-1004
DRAWN: B.D.S.	DATE: JULY 2024
CHECKED: T.G.	SCALE: HOR.:1"=20', VERT.:1"=5'
APPROVED: C.D.P.	SHEET NO. 10 OF 28

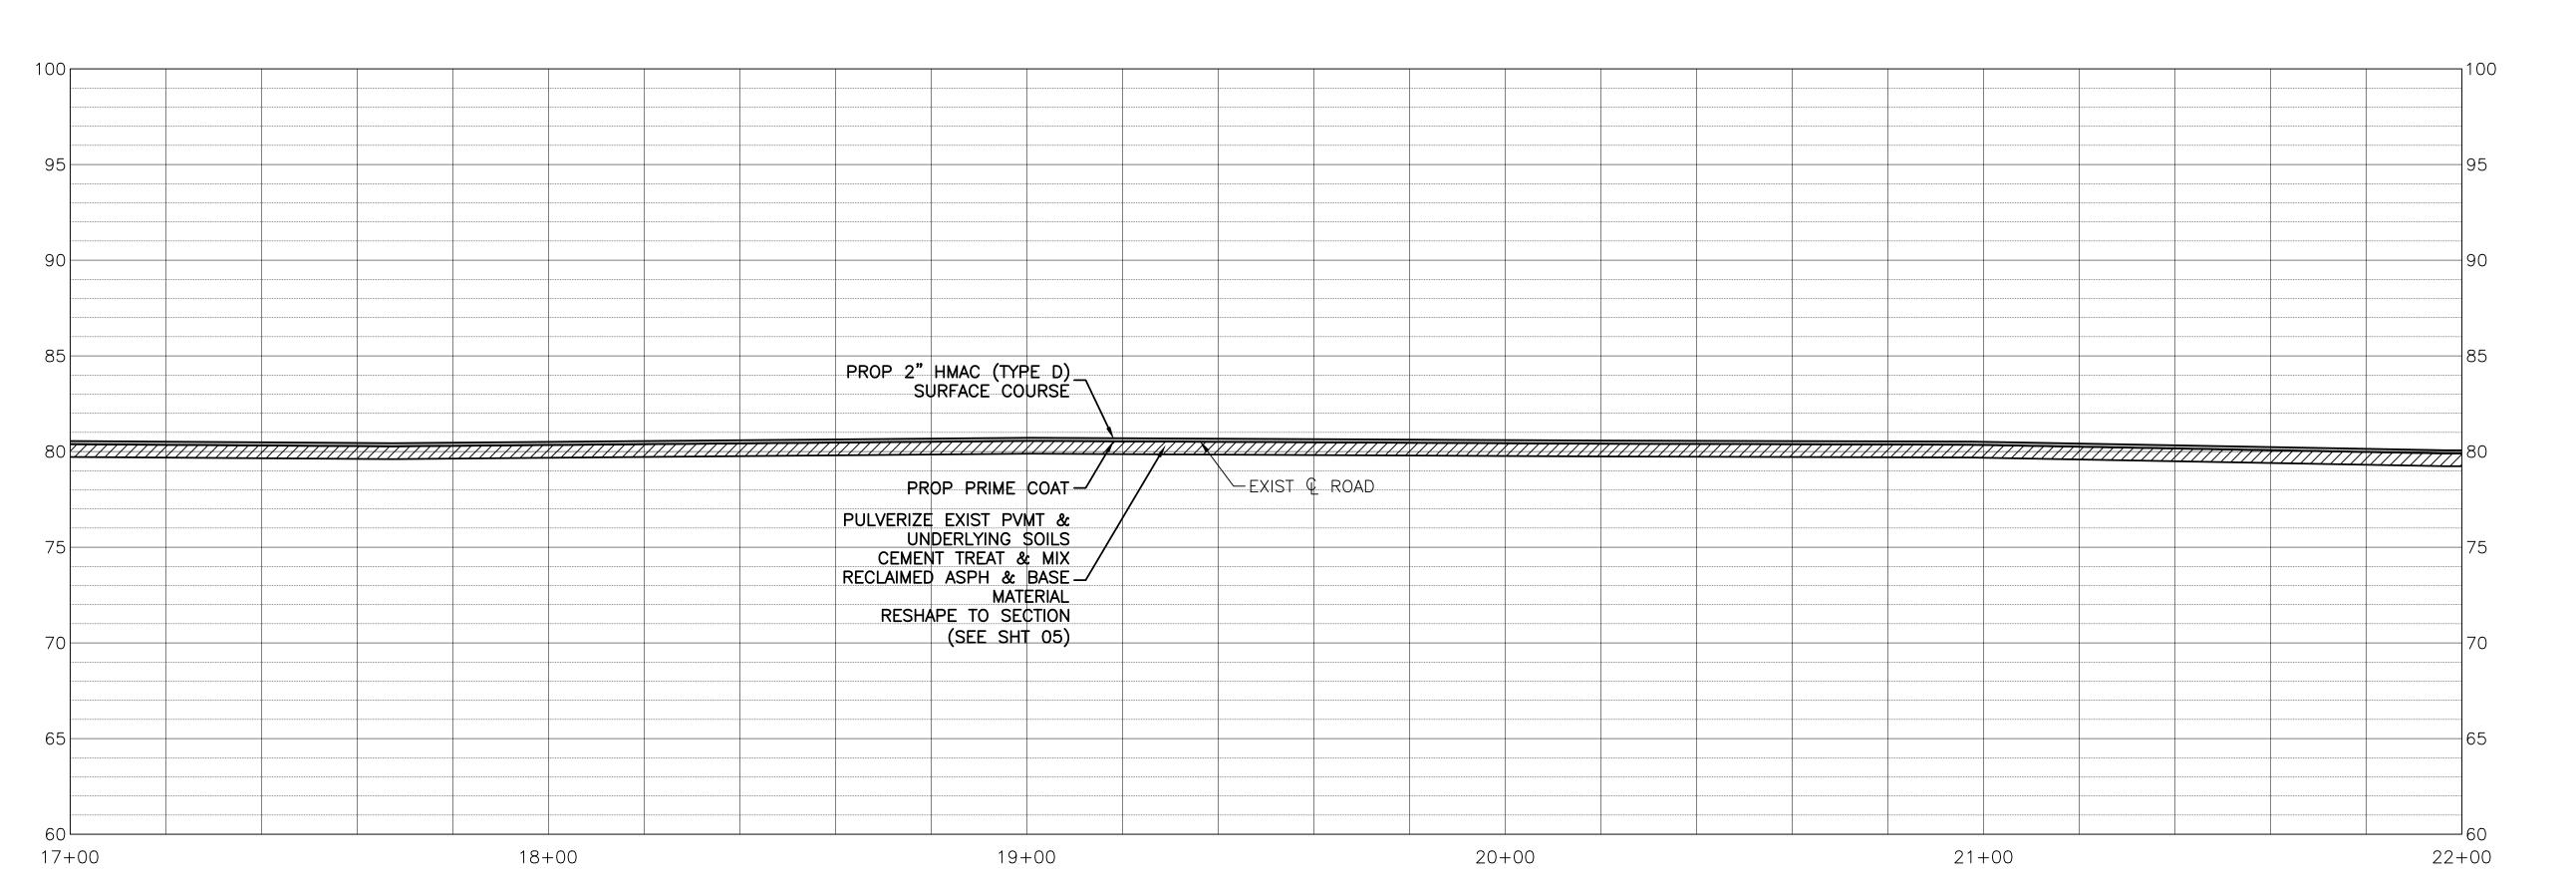

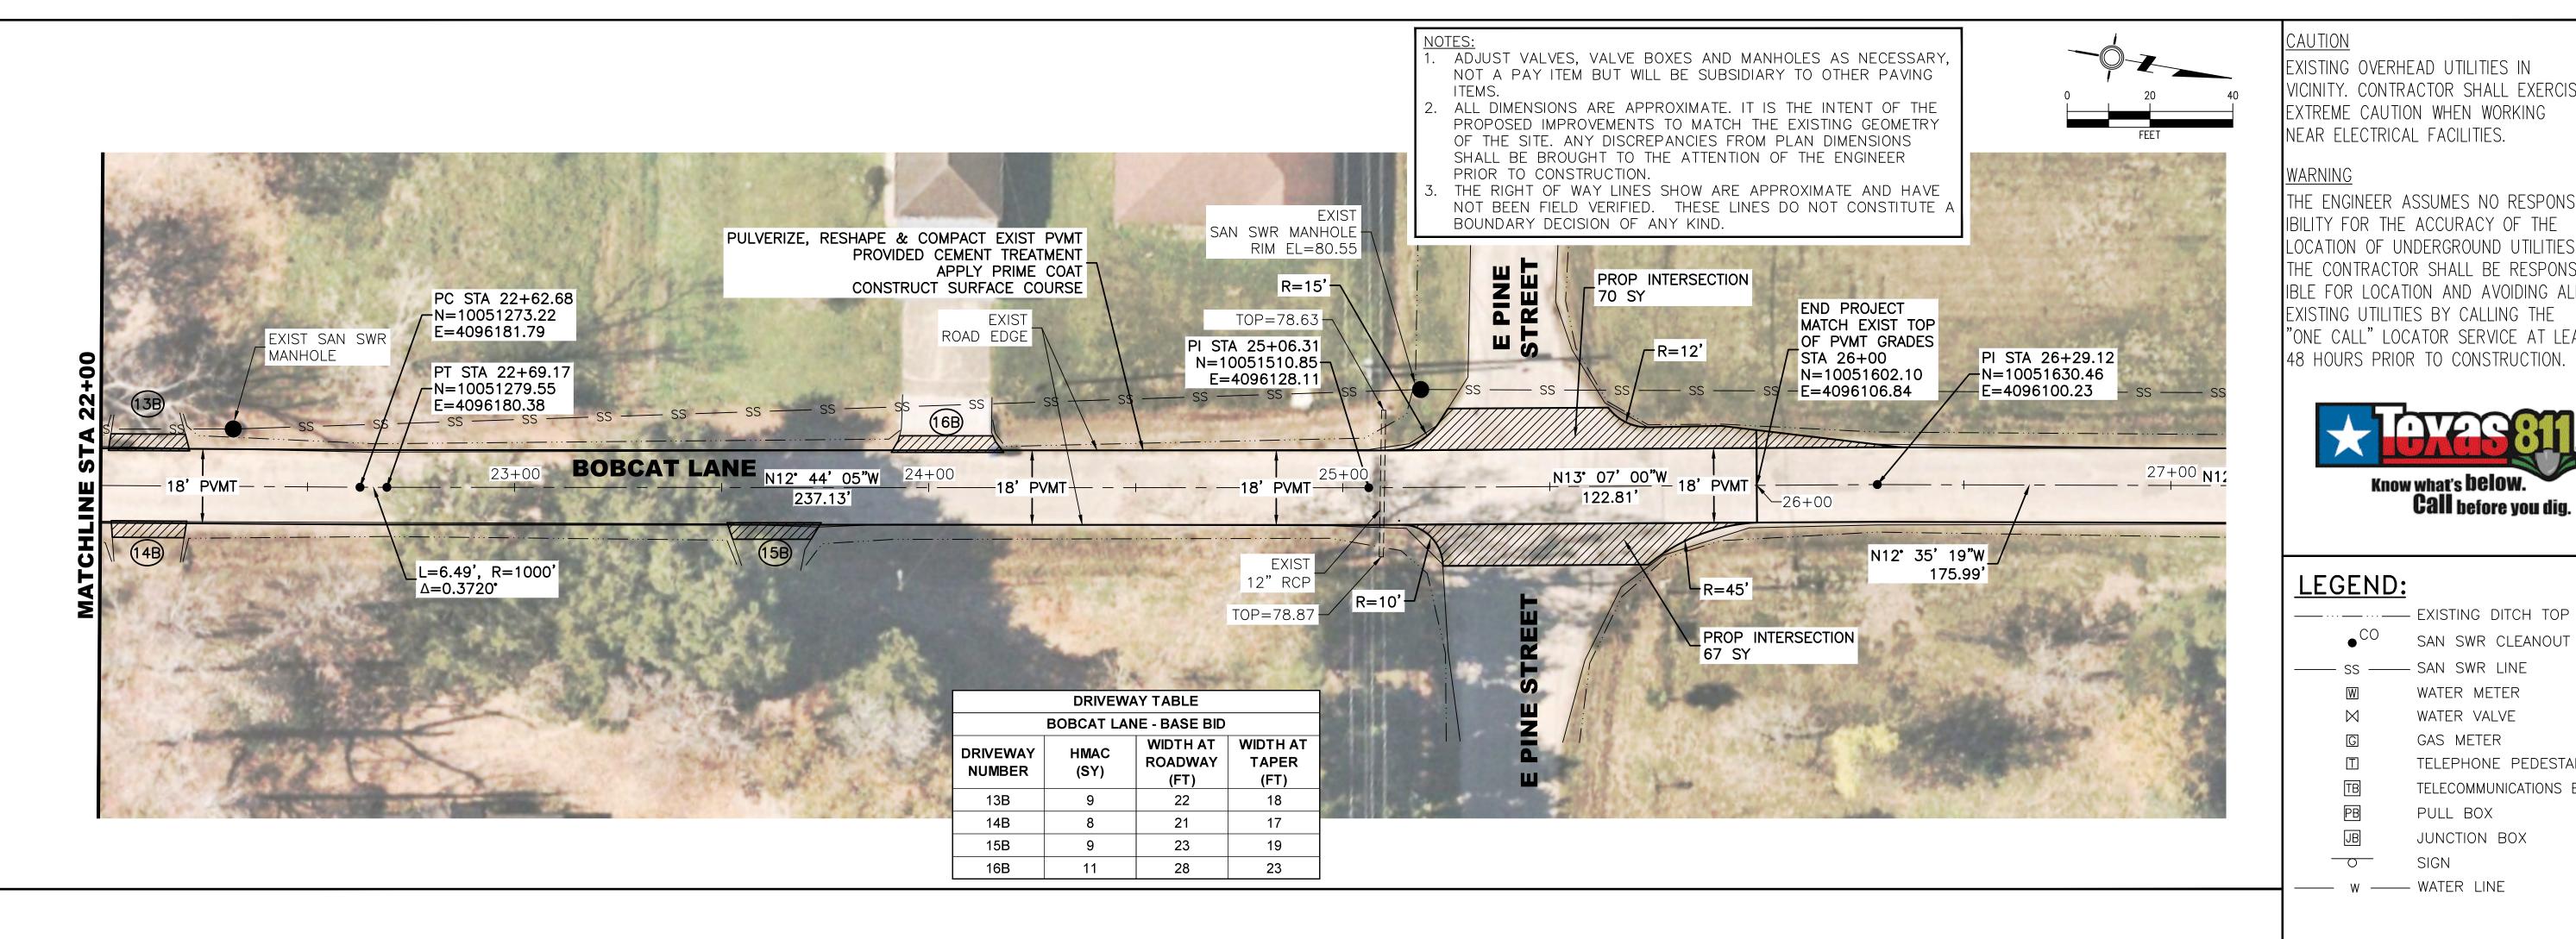

CAUTION

EXISTING OVERHEAD UTILITIES IN VICINITY. CONTRACTOR SHALL EXERCISE EXTREME CAUTION WHEN WORKING NEAR ELECTRICAL FACILITIES.

WARNING

THE ENGINEER ASSUMES NO RESPONS-IBILITY FOR THE ACCURACY OF THE LOCATION OF UNDERGROUND UTILITIES. THE CONTRACTOR SHALL BE RESPONS-IBLE FOR LOCATION AND AVOIDING ALL EXISTING UTILITIES BY CALLING THE "ONE CALL" LOCATOR SERVICE AT LEAST 48 HOURS PRIOR TO CONSTRUCTION.



SAN SWR CLEANOUT

LEGEND:

— SS — SAN SWR LINE WATER METER WATER VALVE GAS METER TELEPHONE PEDESTAL TELECOMMUNICATIONS BOX PULL BOX JB JUNCTION BOX ____

W ---- WATER LINE



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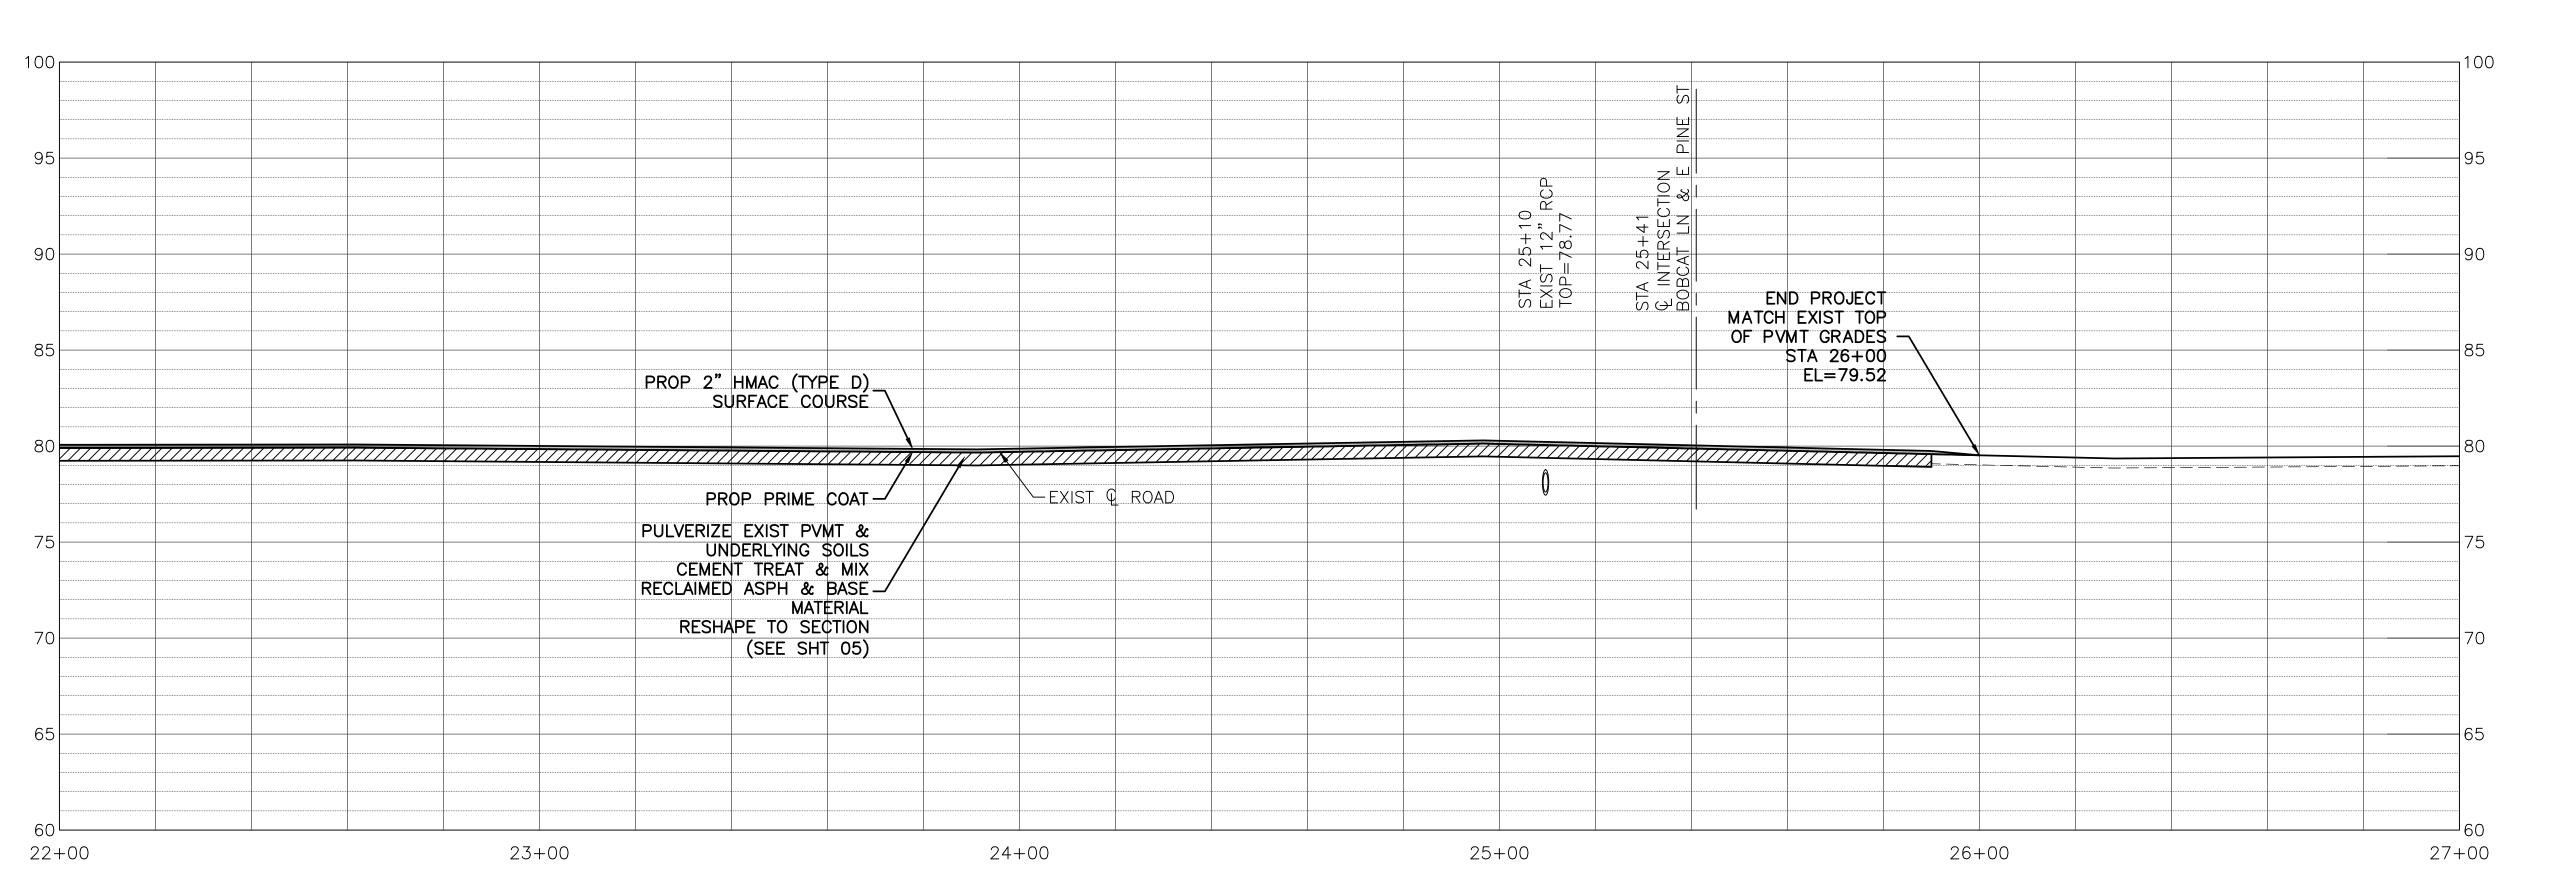
CITY OF DAISETTA, TEXAS **ROAD REHABILITATION PROJECT**


BOBCAT LANE BASE BID STA 22+00 - STA 27+00

LJA Engineering, Inc. 2615 Calder Avenue, Suite 500 Beaumont, Texas 77702

Fax 409.833.031 FRN - F-138

DESIGN: T.G.	JOB NO.: B1246-1004
DRAWN: B.D.S.	DATE: JULY 2024
CHECKED: T.G.	SCALE: HOR.:1"=20', VERT.:1"=5'
APPROVED: C.D.P.	SHEET NO. 11 OF 28



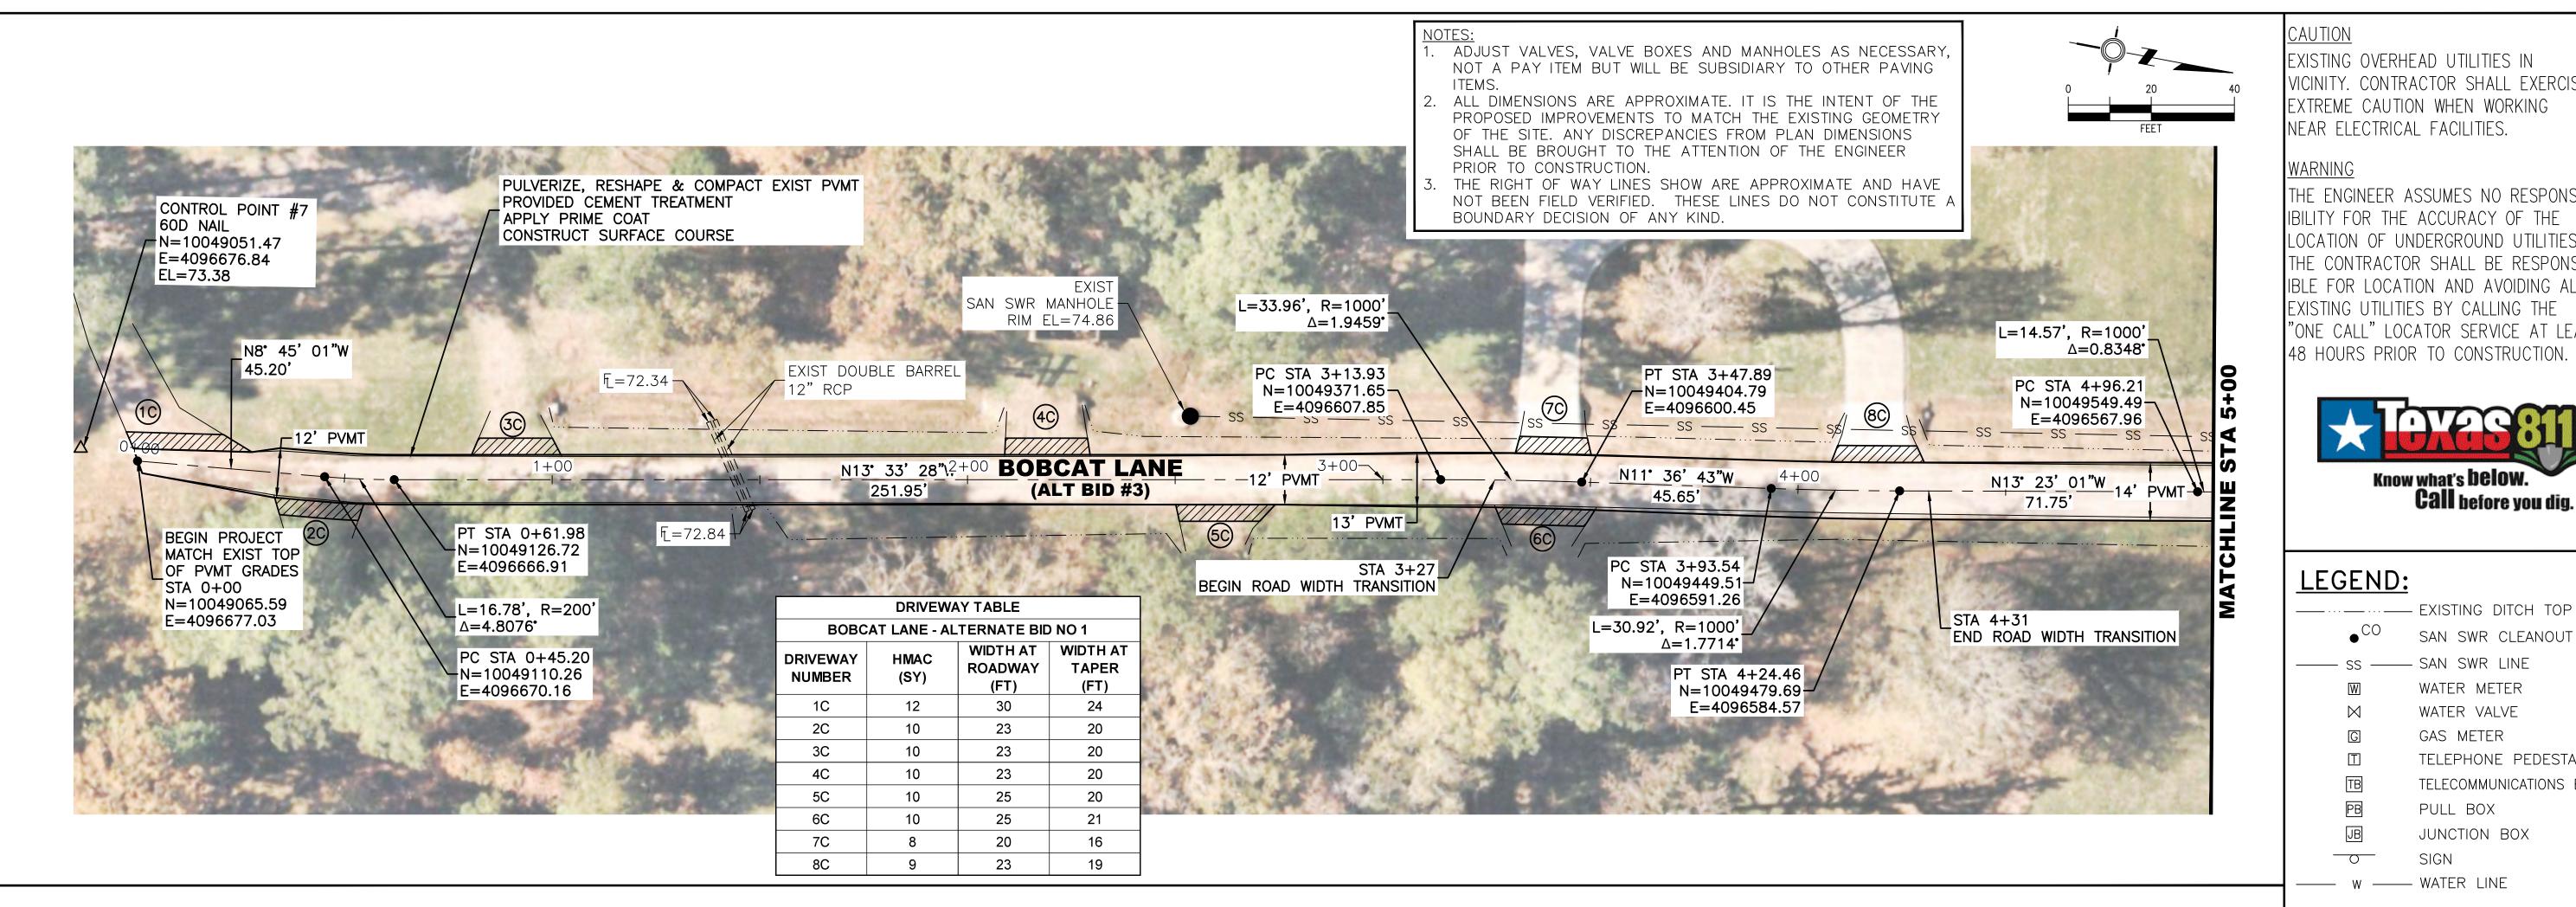

EXISTING OVERHEAD UTILITIES IN VICINITY. CONTRACTOR SHALL EXERCISE EXTREME CAUTION WHEN WORKING NEAR ELECTRICAL FACILITIES.


WARNING

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LEGEND:

● CO	SAN SWR CLEANOUT
ss	- SAN SWR LINE
W	WATER METER
\bowtie	WATER VALVE
G	GAS METER
	TELEPHONE PEDESTAL
TB	TELECOMMUNICATIONS BOX
PB	PULL BOX
JB	JUNCTION BOX
	SIGN



THIS DOCUMENT WAS AUTHORIZED BY CALVIN D.

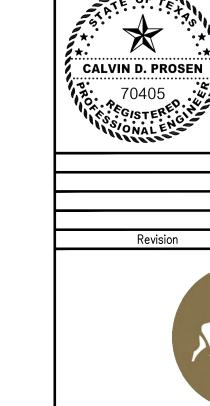By Chk. Appr. Date




CITY OF DAISETTA, TEXAS **ROAD REHABILITATION PROJECT**


> **BOBCAT LANE ALTERNATE BID NO 3** STA 0+00 - STA 5+00


LJA Engineering, Inc. 2615 Calder Avenue, Suite 500 Beaumont, Texas 77702

DESIGN: T.G. JOB NO.: B1246-1004 DATE: JULY 2024 DRAWN: B.D.S. CHECKED: T.G. SCALE: HOR.: 1"=20', VERT.: 1"=5' APPROVED: C.D.P. SHEET NO. 12 OF 28

Fax 409.833.031 FRN - F-138

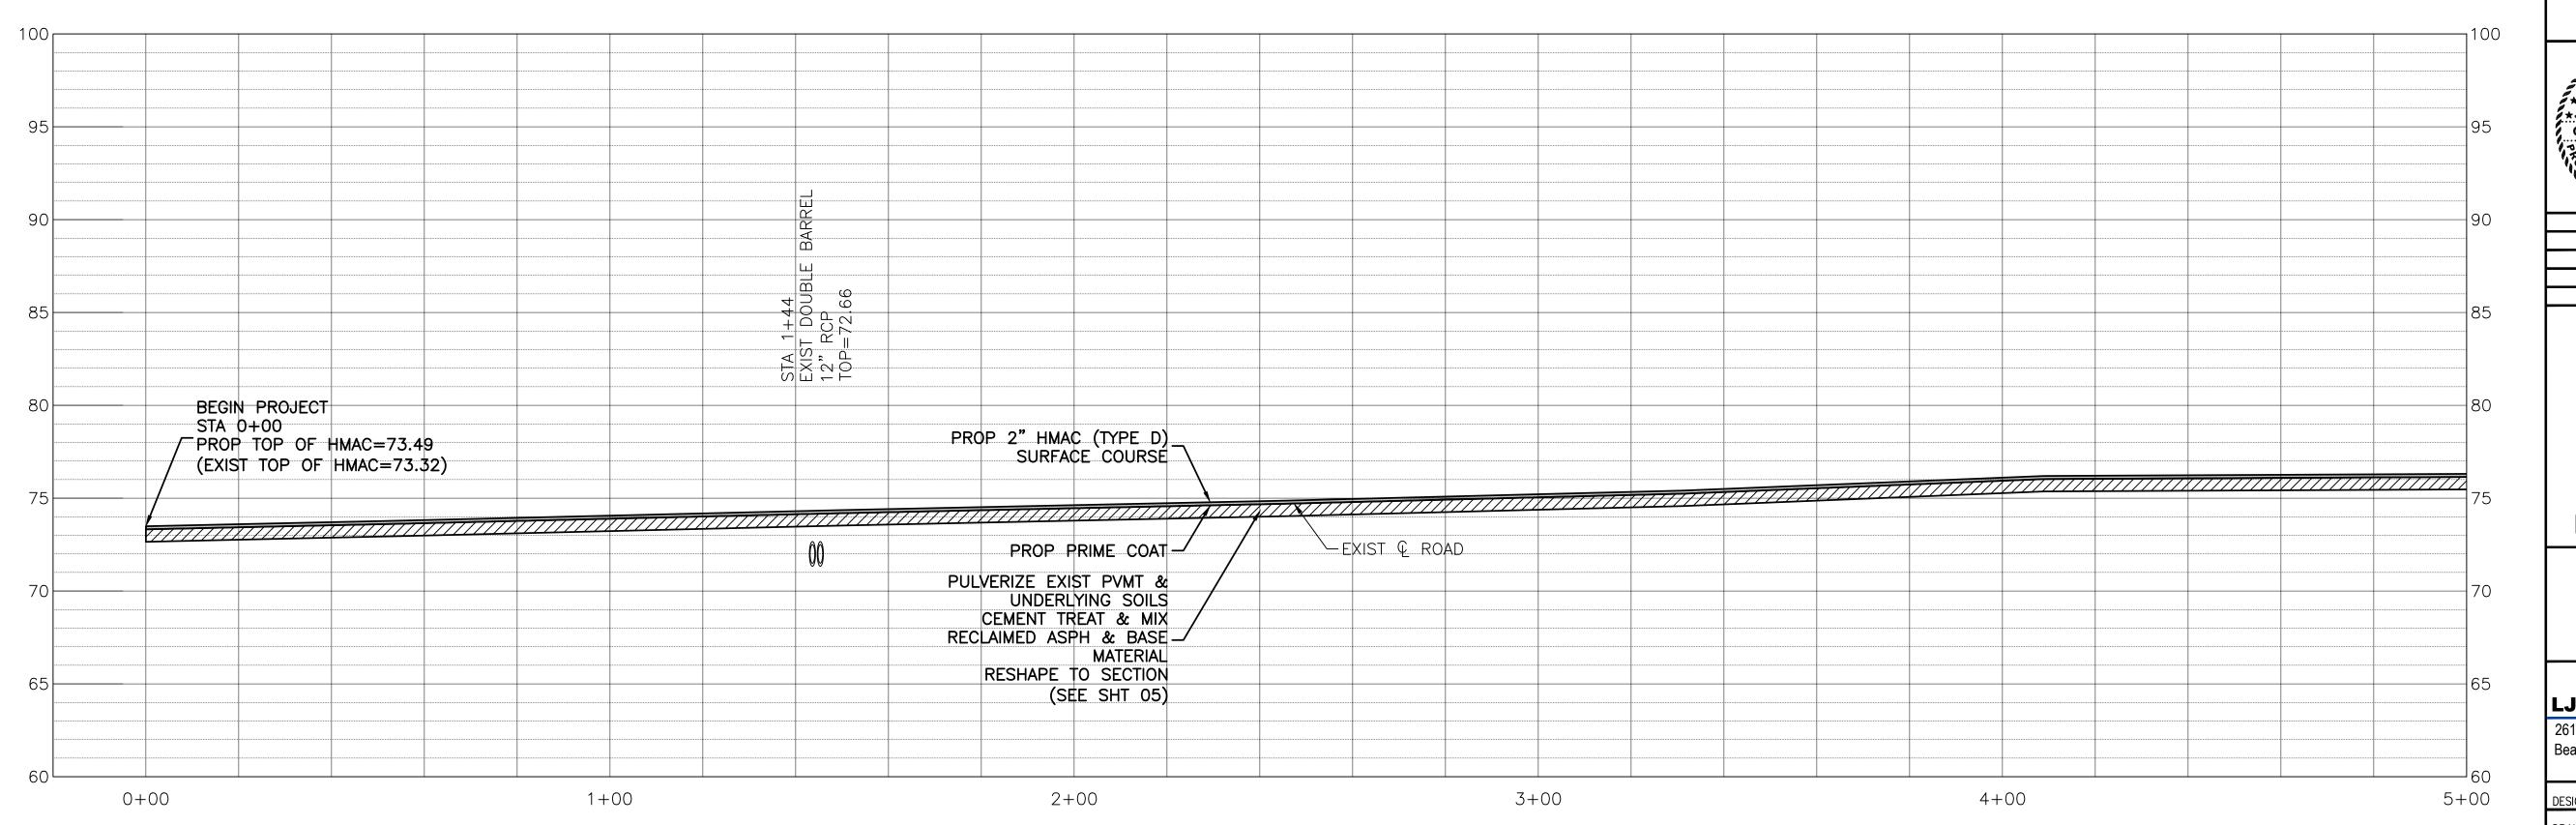

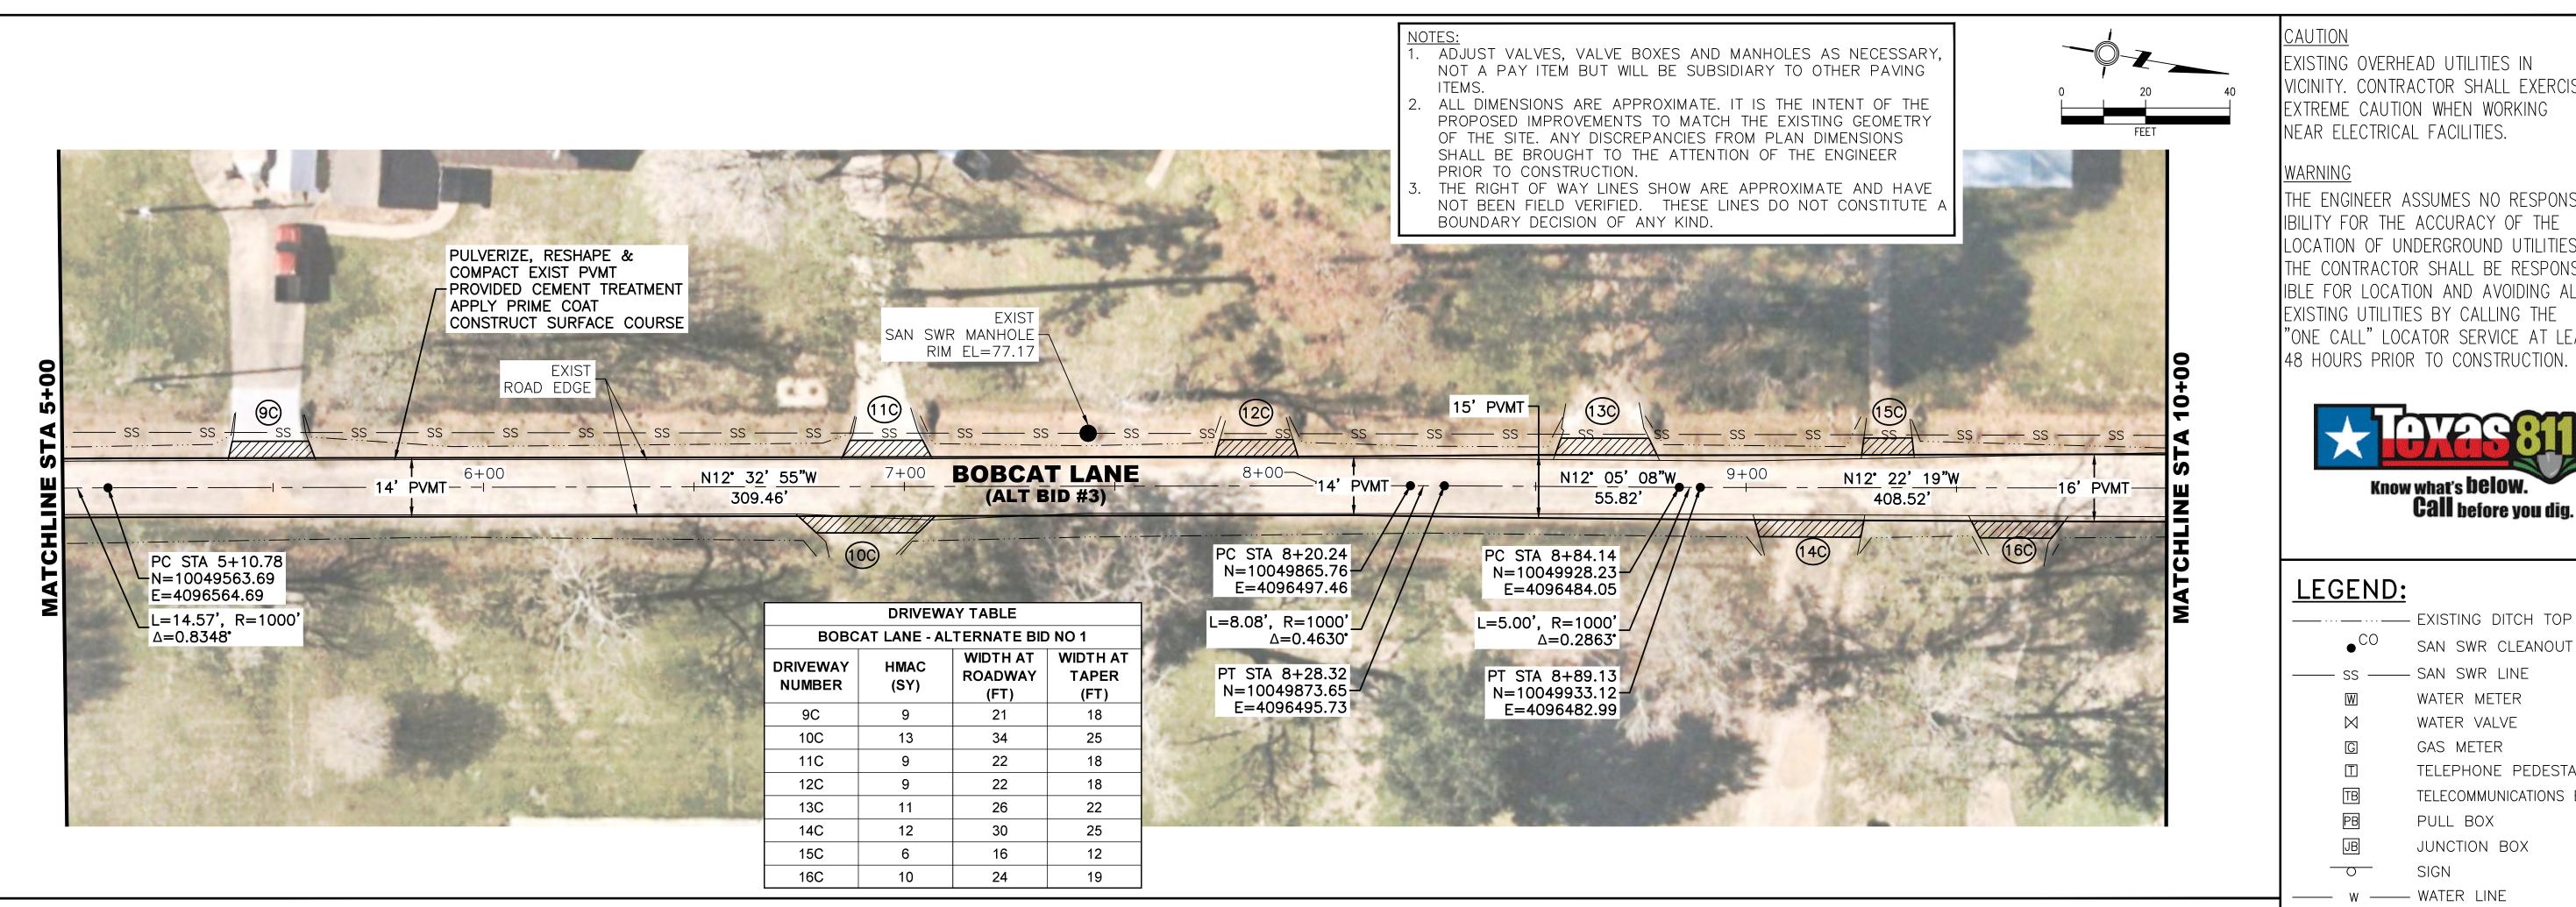

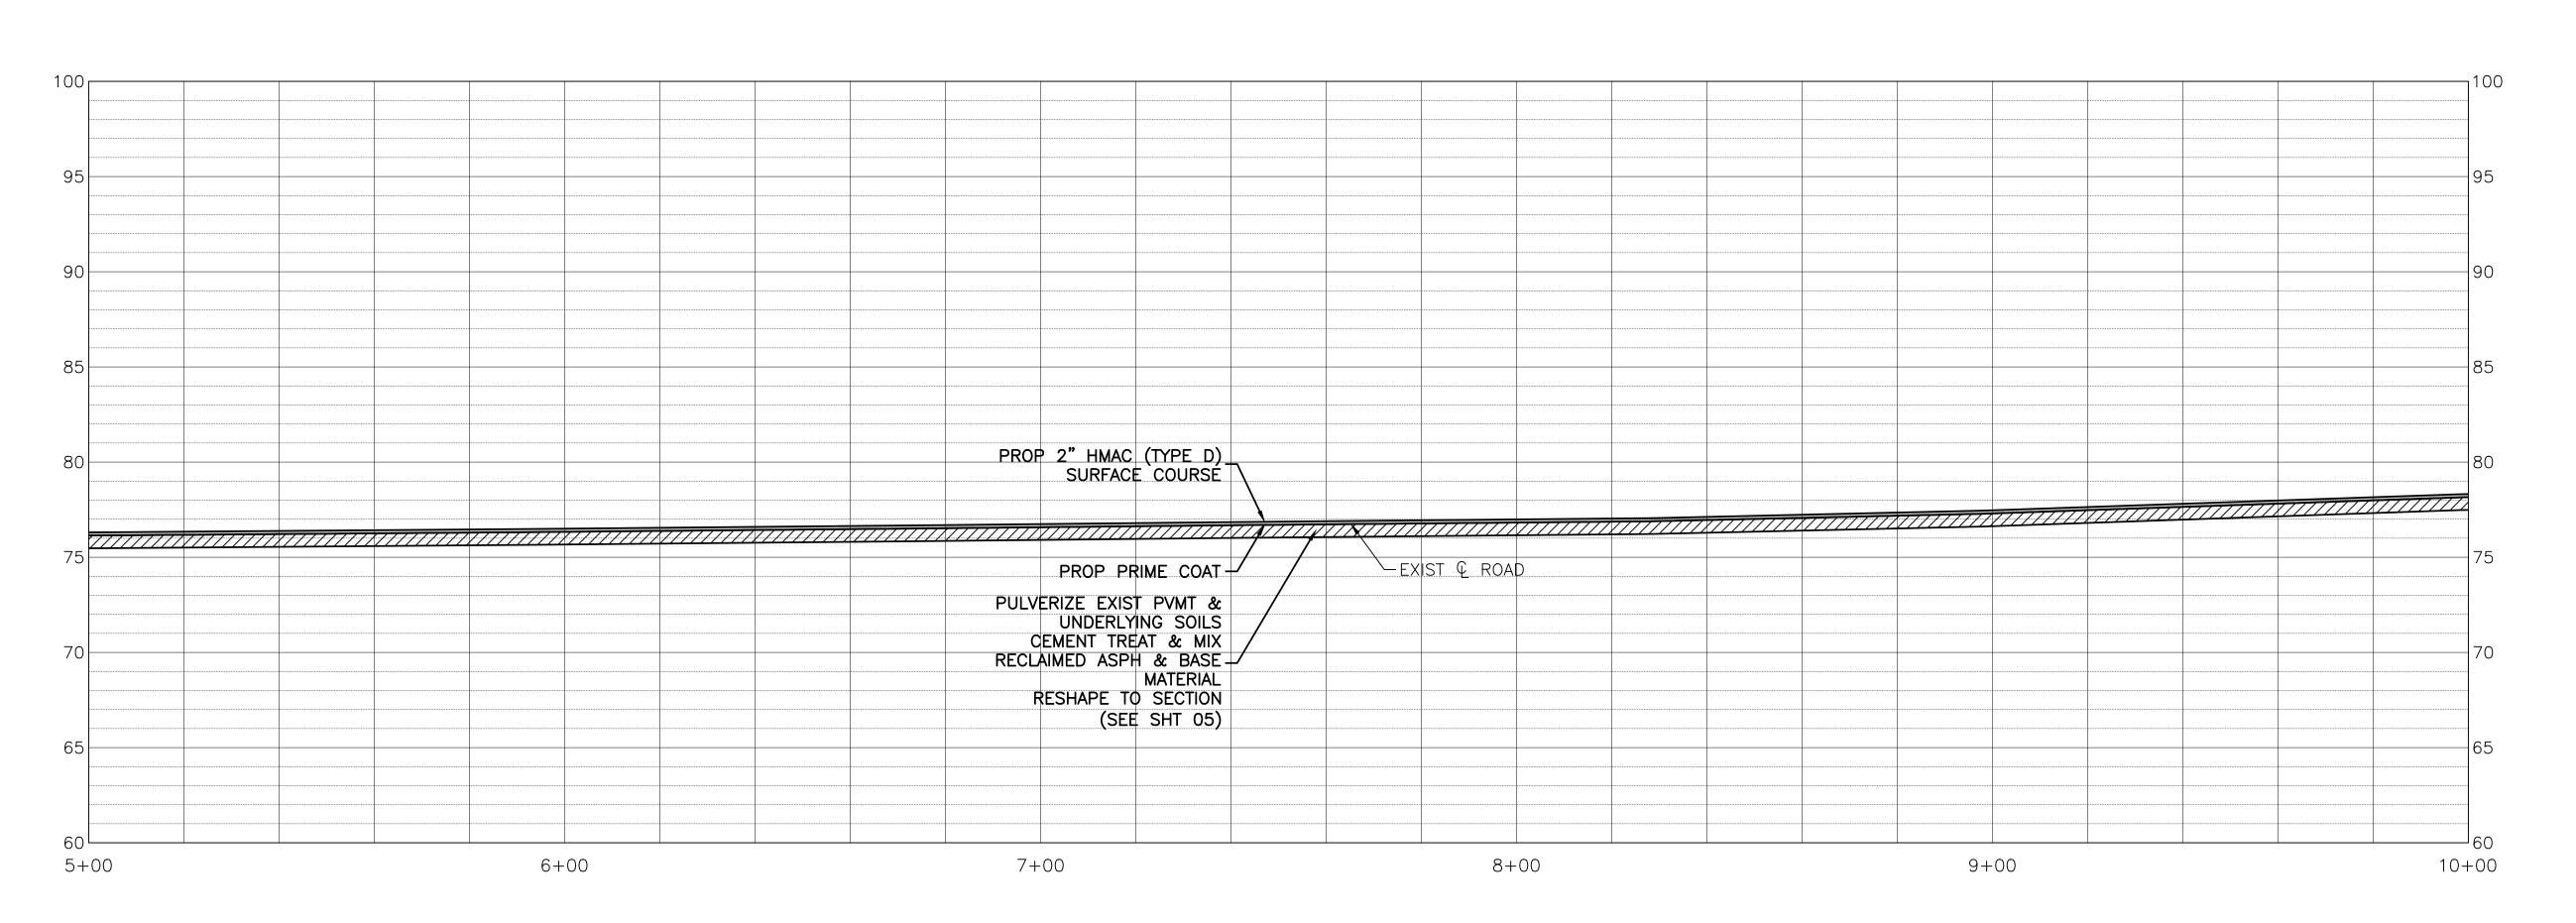

<u>CAUTION</u>

EXISTING OVERHEAD UTILITIES IN VICINITY. CONTRACTOR SHALL EXERCISE EXTREME CAUTION WHEN WORKING NEAR ELECTRICAL FACILITIES.

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LEGEND:


● CO	SAN SWR CLEANOUT
—— ss ——	SAN SWR LINE
W	WATER METER
\bowtie	WATER VALVE
G	GAS METER
	TELEPHONE PEDESTA
TB	TELECOMMUNICATIONS E
PB	PULL BOX
JB	JUNCTION BOX
	SIGN

---- W ----- WATER LINE



THE SEAL APPEARING ON THIS DOCUMENT WAS

By Chk. Appr. Date Revision

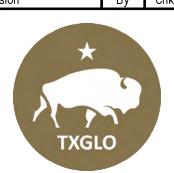


CITY OF DAISETTA, TEXAS **ROAD REHABILITATION PROJECT**


> **BOBCAT LANE ALTERNATE BID NO 3** STA 5+00 - STA 10+00

LJA Engineering, Inc. 2615 Calder Avenue, Suite 500 Beaumont, Texas 77702

Phone 409.833.336 Fax 409.833.031 FRN - F-138

DESIGN: T.G.	JOB NO.: B1246-1004
DRAWN: B.D.S.	DATE: JULY 2024
CHECKED: T.G.	SCALE: HOR.:1"=20', VERT.:1"=5'
∆PPR∩VFN· C N P	SHEET NO. 13 OF 28

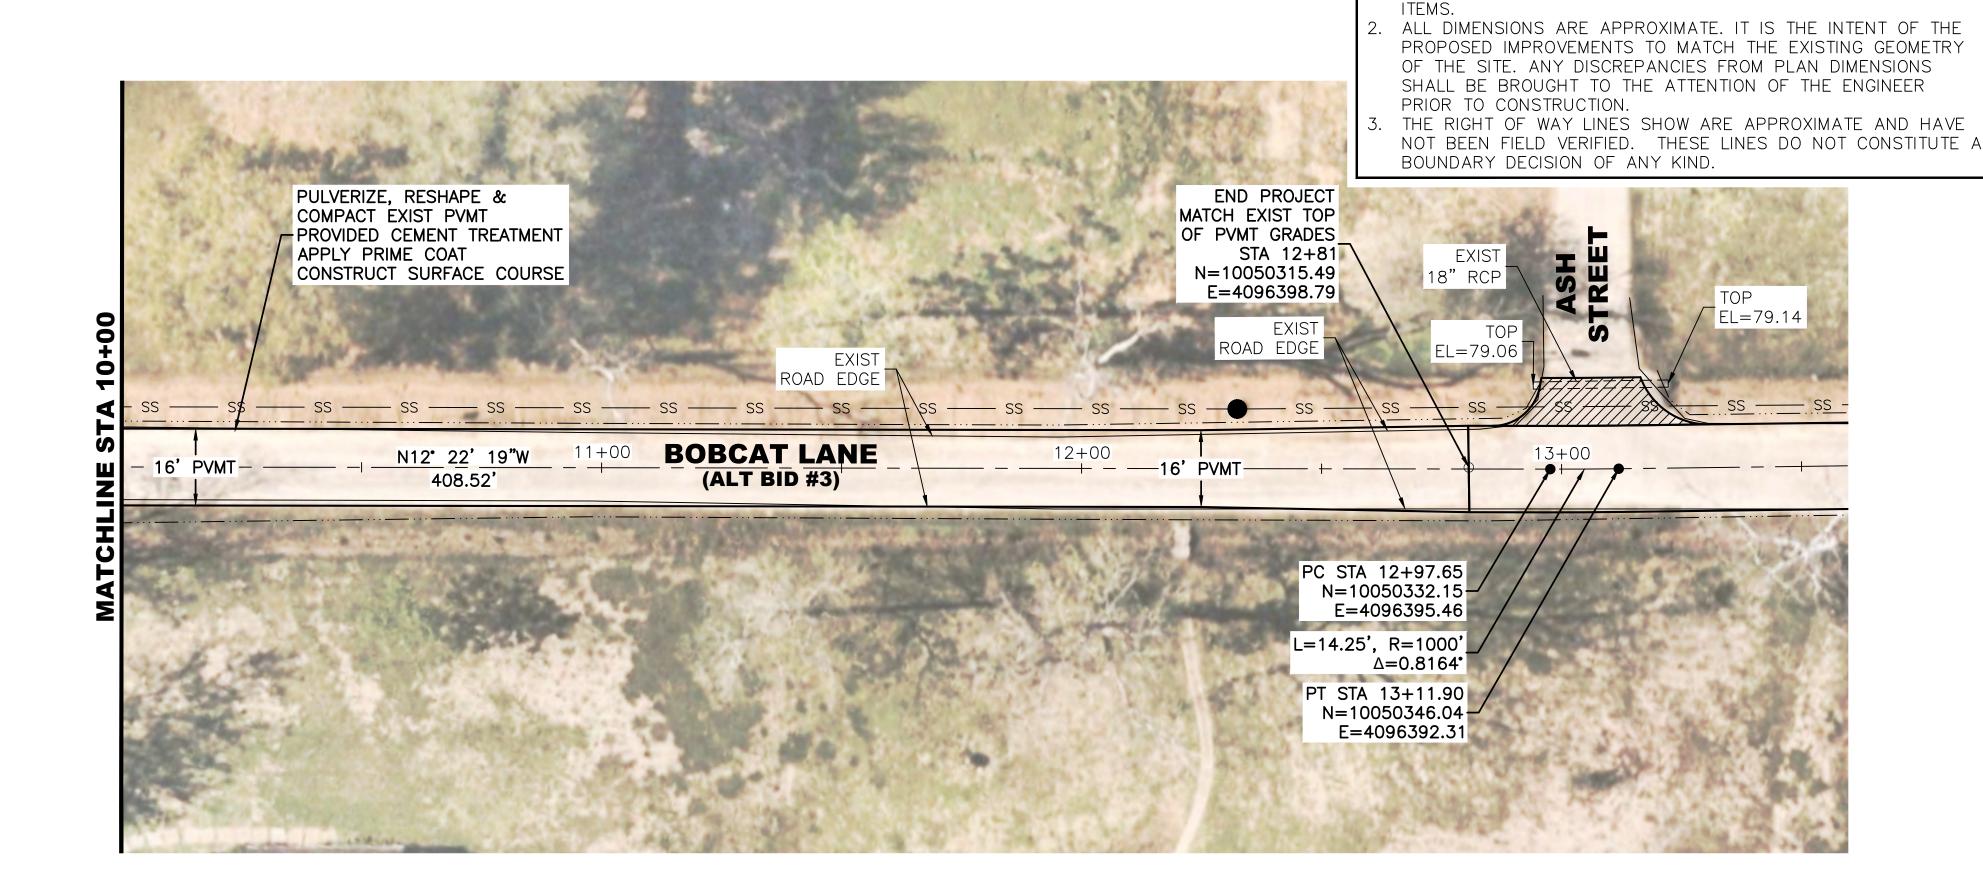

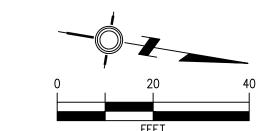

1. ADJUST VALVES, VALVE BOXES AND MANHOLES AS NECESSARY

NOT A PAY ITEM BUT WILL BE SUBSIDIARY TO OTHER PAVING

<u>CAUTION</u>

EXISTING OVERHEAD UTILITIES IN VICINITY. CONTRACTOR SHALL EXERCISE EXTREME CAUTION WHEN WORKING NEAR ELECTRICAL FACILITIES.

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LEGEND:

● CO	SAN SWR CLEANOUT
ss	SAN SWR LINE
W	WATER METER
\bowtie	WATER VALVE
G	GAS METER
	TELEPHONE PEDESTA
TB	TELECOMMUNICATIONS E
PB	PULL BOX
JB	JUNCTION BOX
	SIGN

---- W ---- WATER LINE

------ EXISTING DITCH TOP



THIS DOCUMENT WAS AUTHORIZED BY CALVIN D.

By Chk. Appr. Date Revision




CITY OF DAISETTA, TEXAS **ROAD REHABILITATION PROJECT**


> **BOBCAT LANE ALTERNATE BID NO 3** STA 10+00 - STA 14+50

LJA Engineering, Inc. 2615 Calder Avenue, Suite 500

Phone 409.833.336 Fax 409.833.031 Beaumont, Texas 77702 FRN - F-138

DESIGN: T.G.	JOB NO.: B1246-1004
DRAWN: B.D.S.	DATE: JULY 2024
CHECKED: T.G.	SCALE: HOR.:1"=20', VERT.:1"=5'
APPROVED: C.D.P.	SHEET NO. 14 OF 28

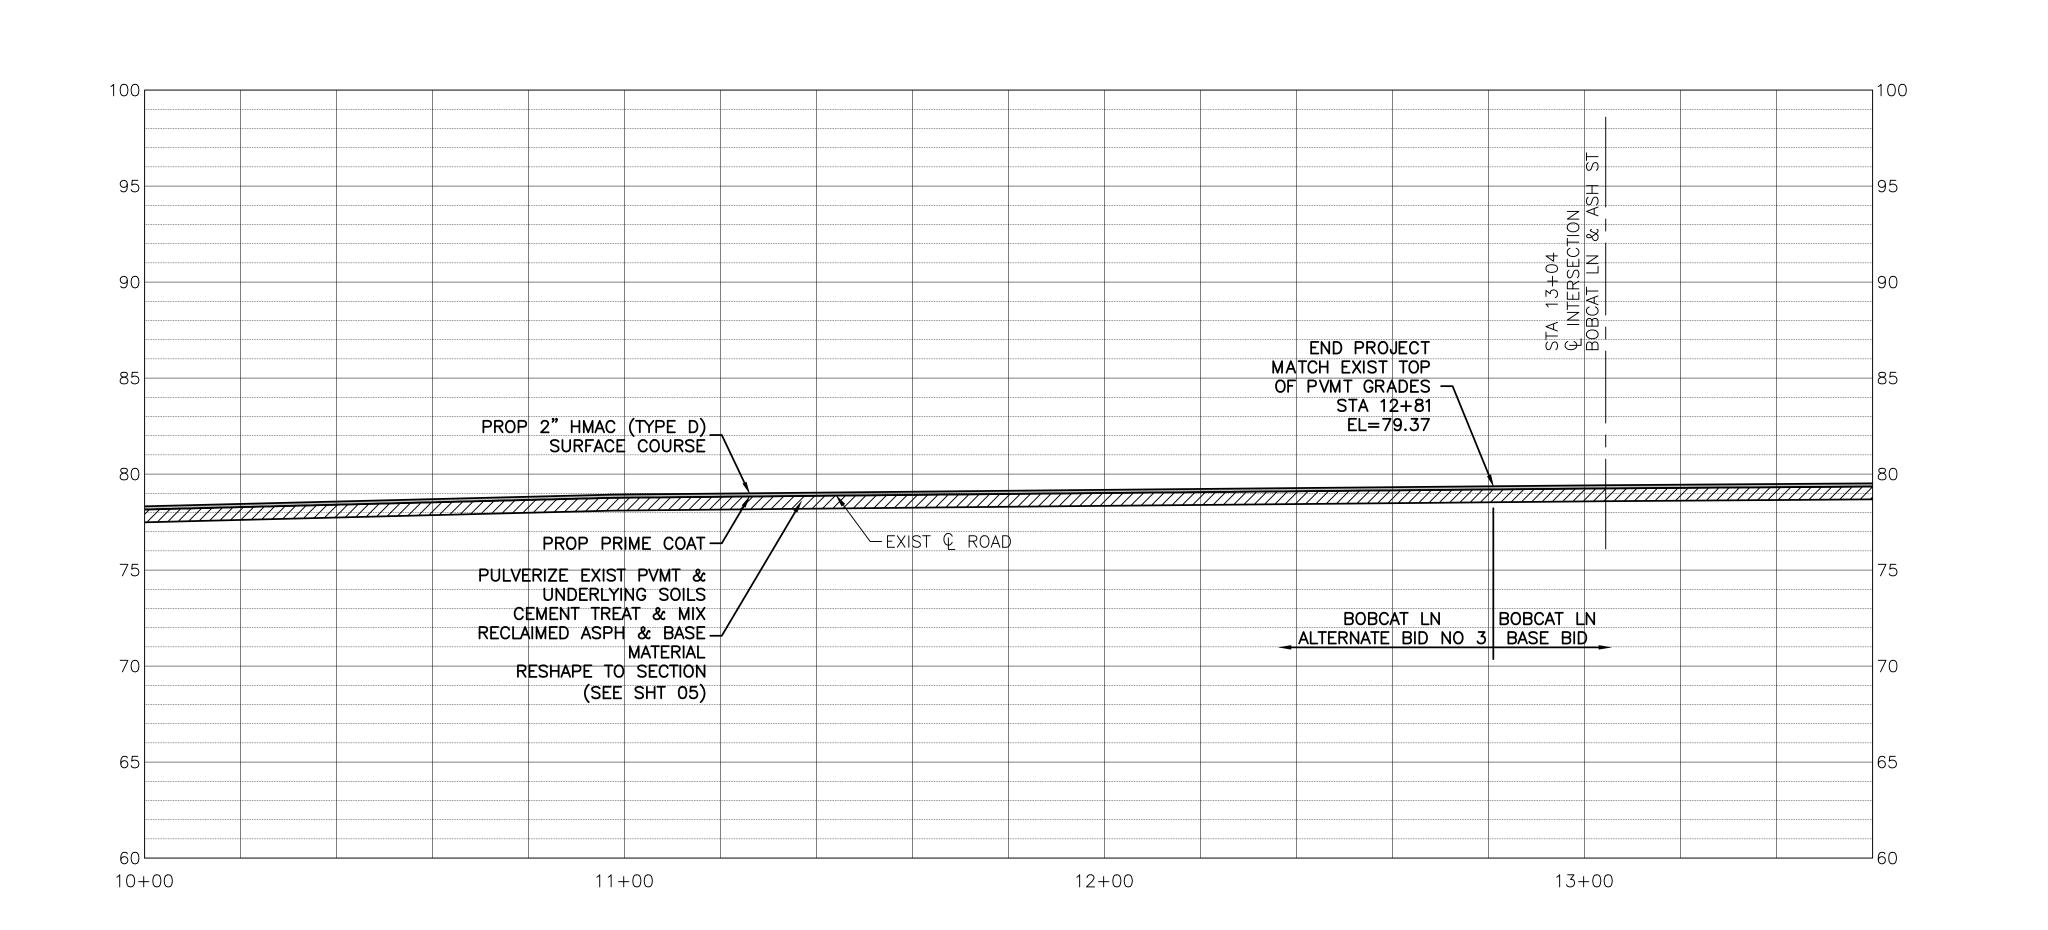

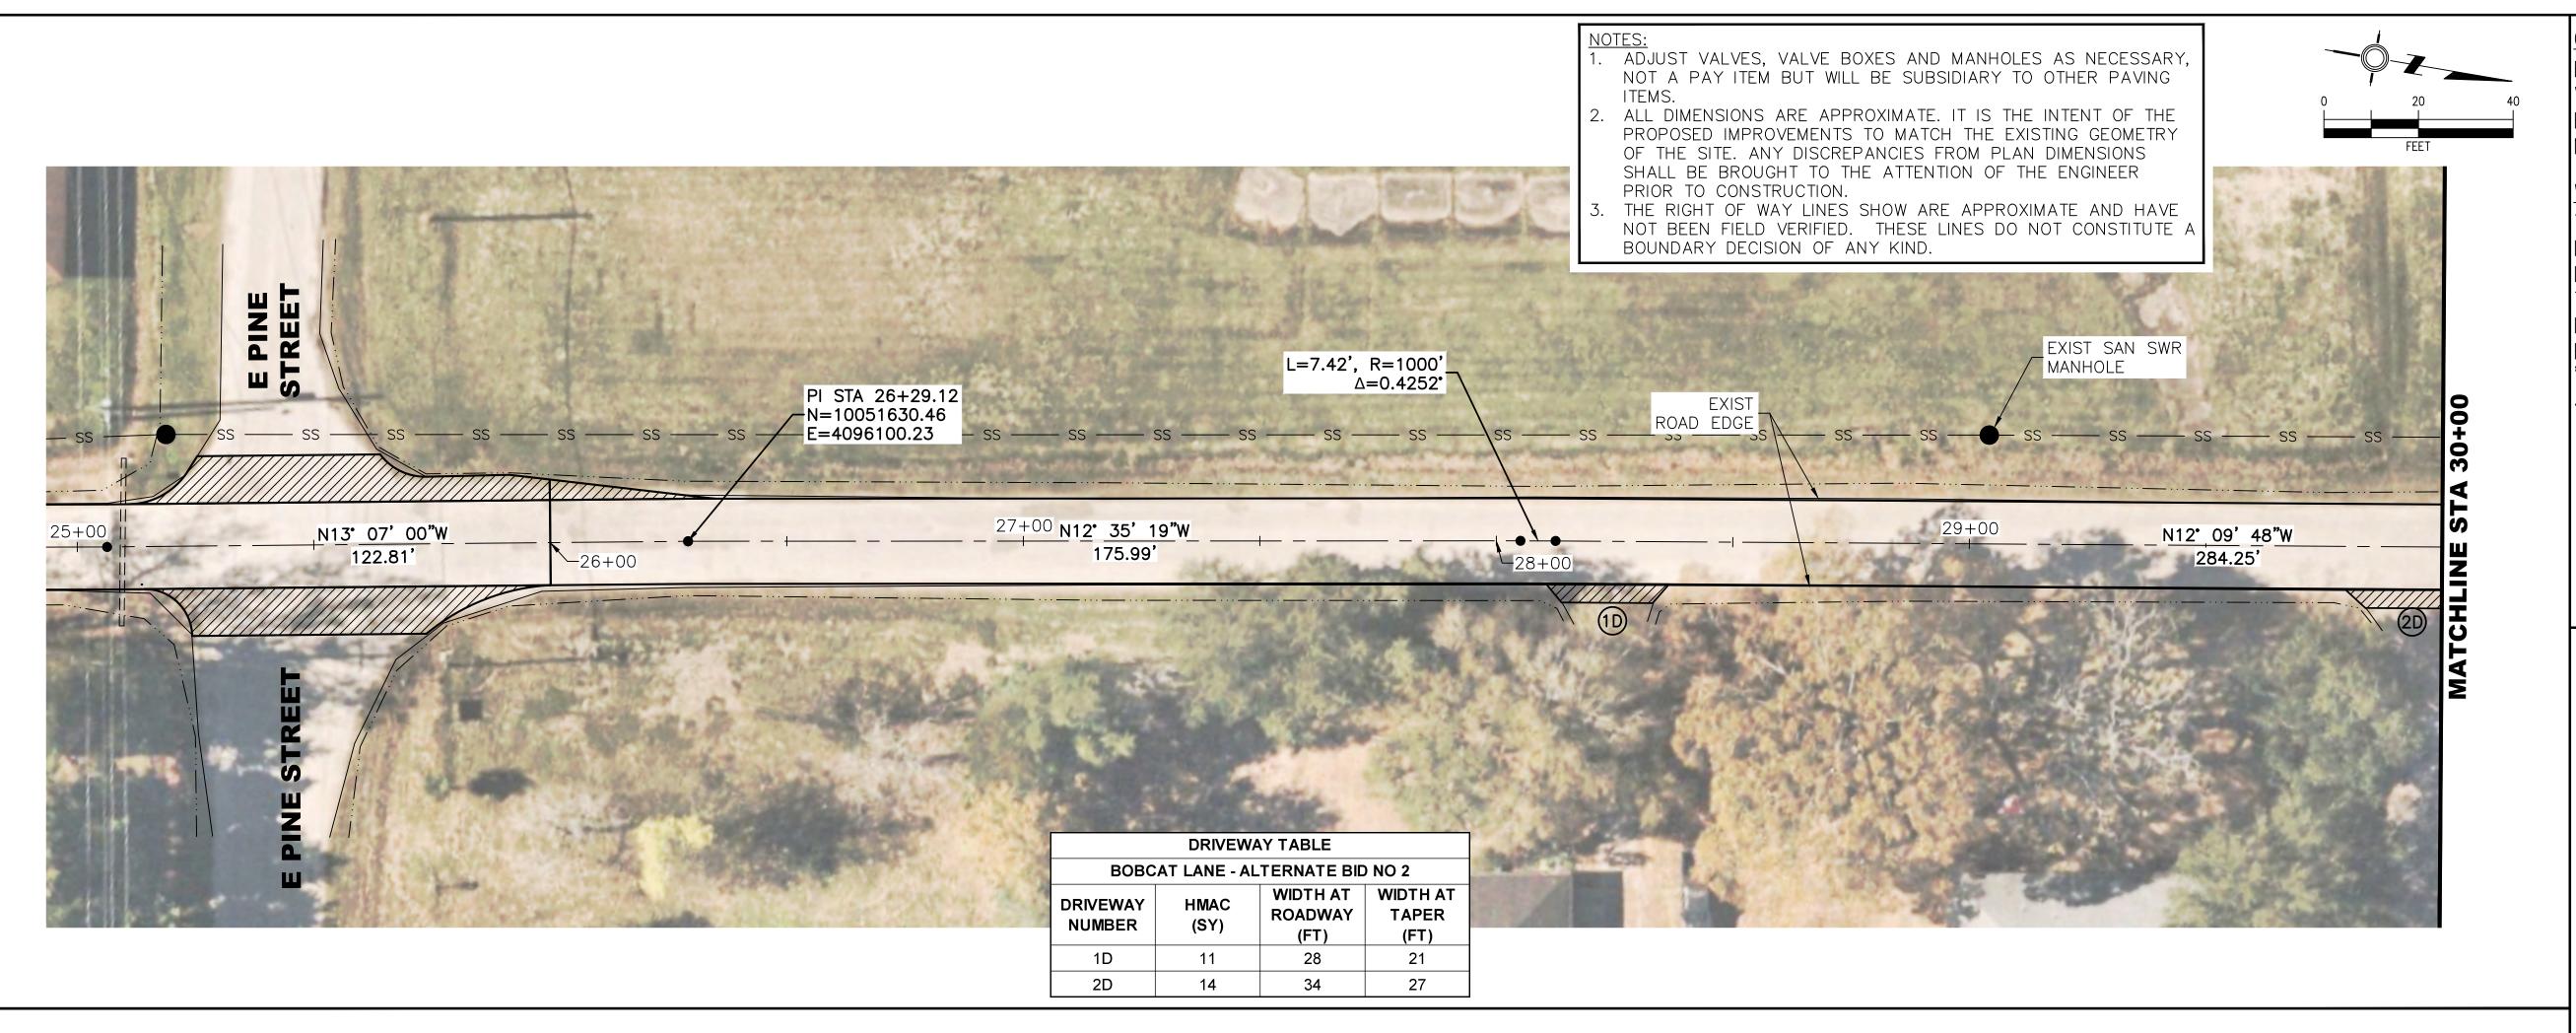

<u>CAUTION</u>

EXISTING OVERHEAD UTILITIES IN VICINITY. CONTRACTOR SHALL EXERCISE EXTREME CAUTION WHEN WORKING NEAR ELECTRICAL FACILITIES.

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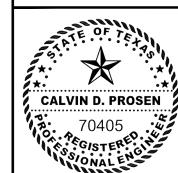


LEGEND:

• 00	SAN SWR CLEANOUT
ss	– SAN SWR LINE
W	WATER METER
\bowtie	WATER VALVE
G	GAS METER
	TELEPHONE PEDESTA
TB	TELECOMMUNICATIONS
PB	PULL BOX
JB	JUNCTION BOX
	SIGN


--- W ---- WATER LINE

------ EXISTING DITCH TOP



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Revision By Chk. Appr. Date

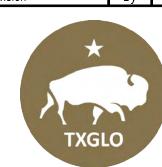


CITY OF DAISETTA, TEXAS **ROAD REHABILITATION PROJECT**


BOBCAT LANE ALTERNATE BID NO 5 STA 25+00 - STA 30+00

LJA Engineering, Inc. 2615 Calder Avenue, Suite 500 Beaumont, Texas 77702

Fax 409.833.031 FRN - F-138

DESIGN: T.G. JOB NO.: B1246-1004 DRAWN: B.D.S. DATE: JULY 2024 CHECKED: T.G. SCALE: HOR.:1"=20', VERT.:1"=5' APPROVED: C.D.P. SHEET NO. 15 OF 28

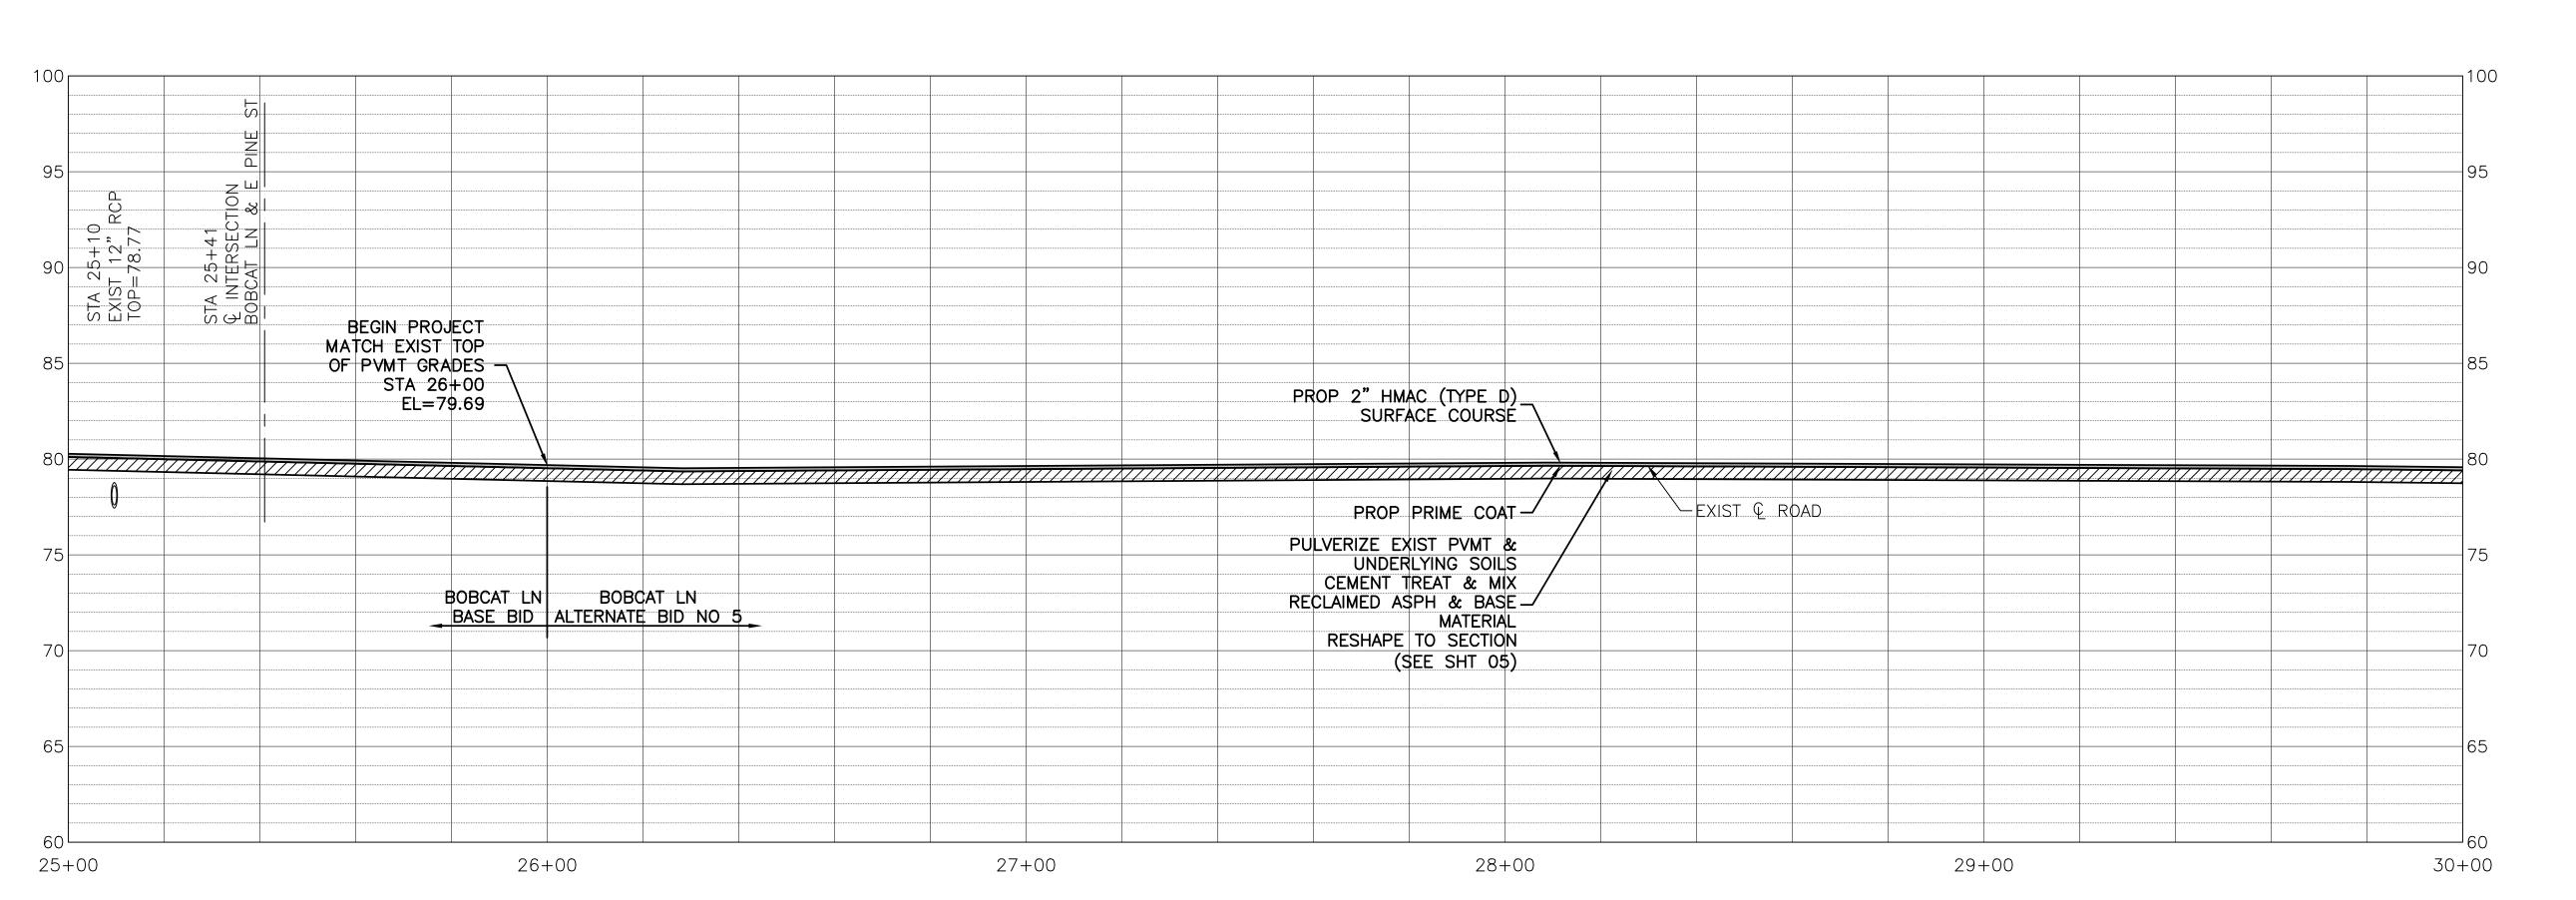

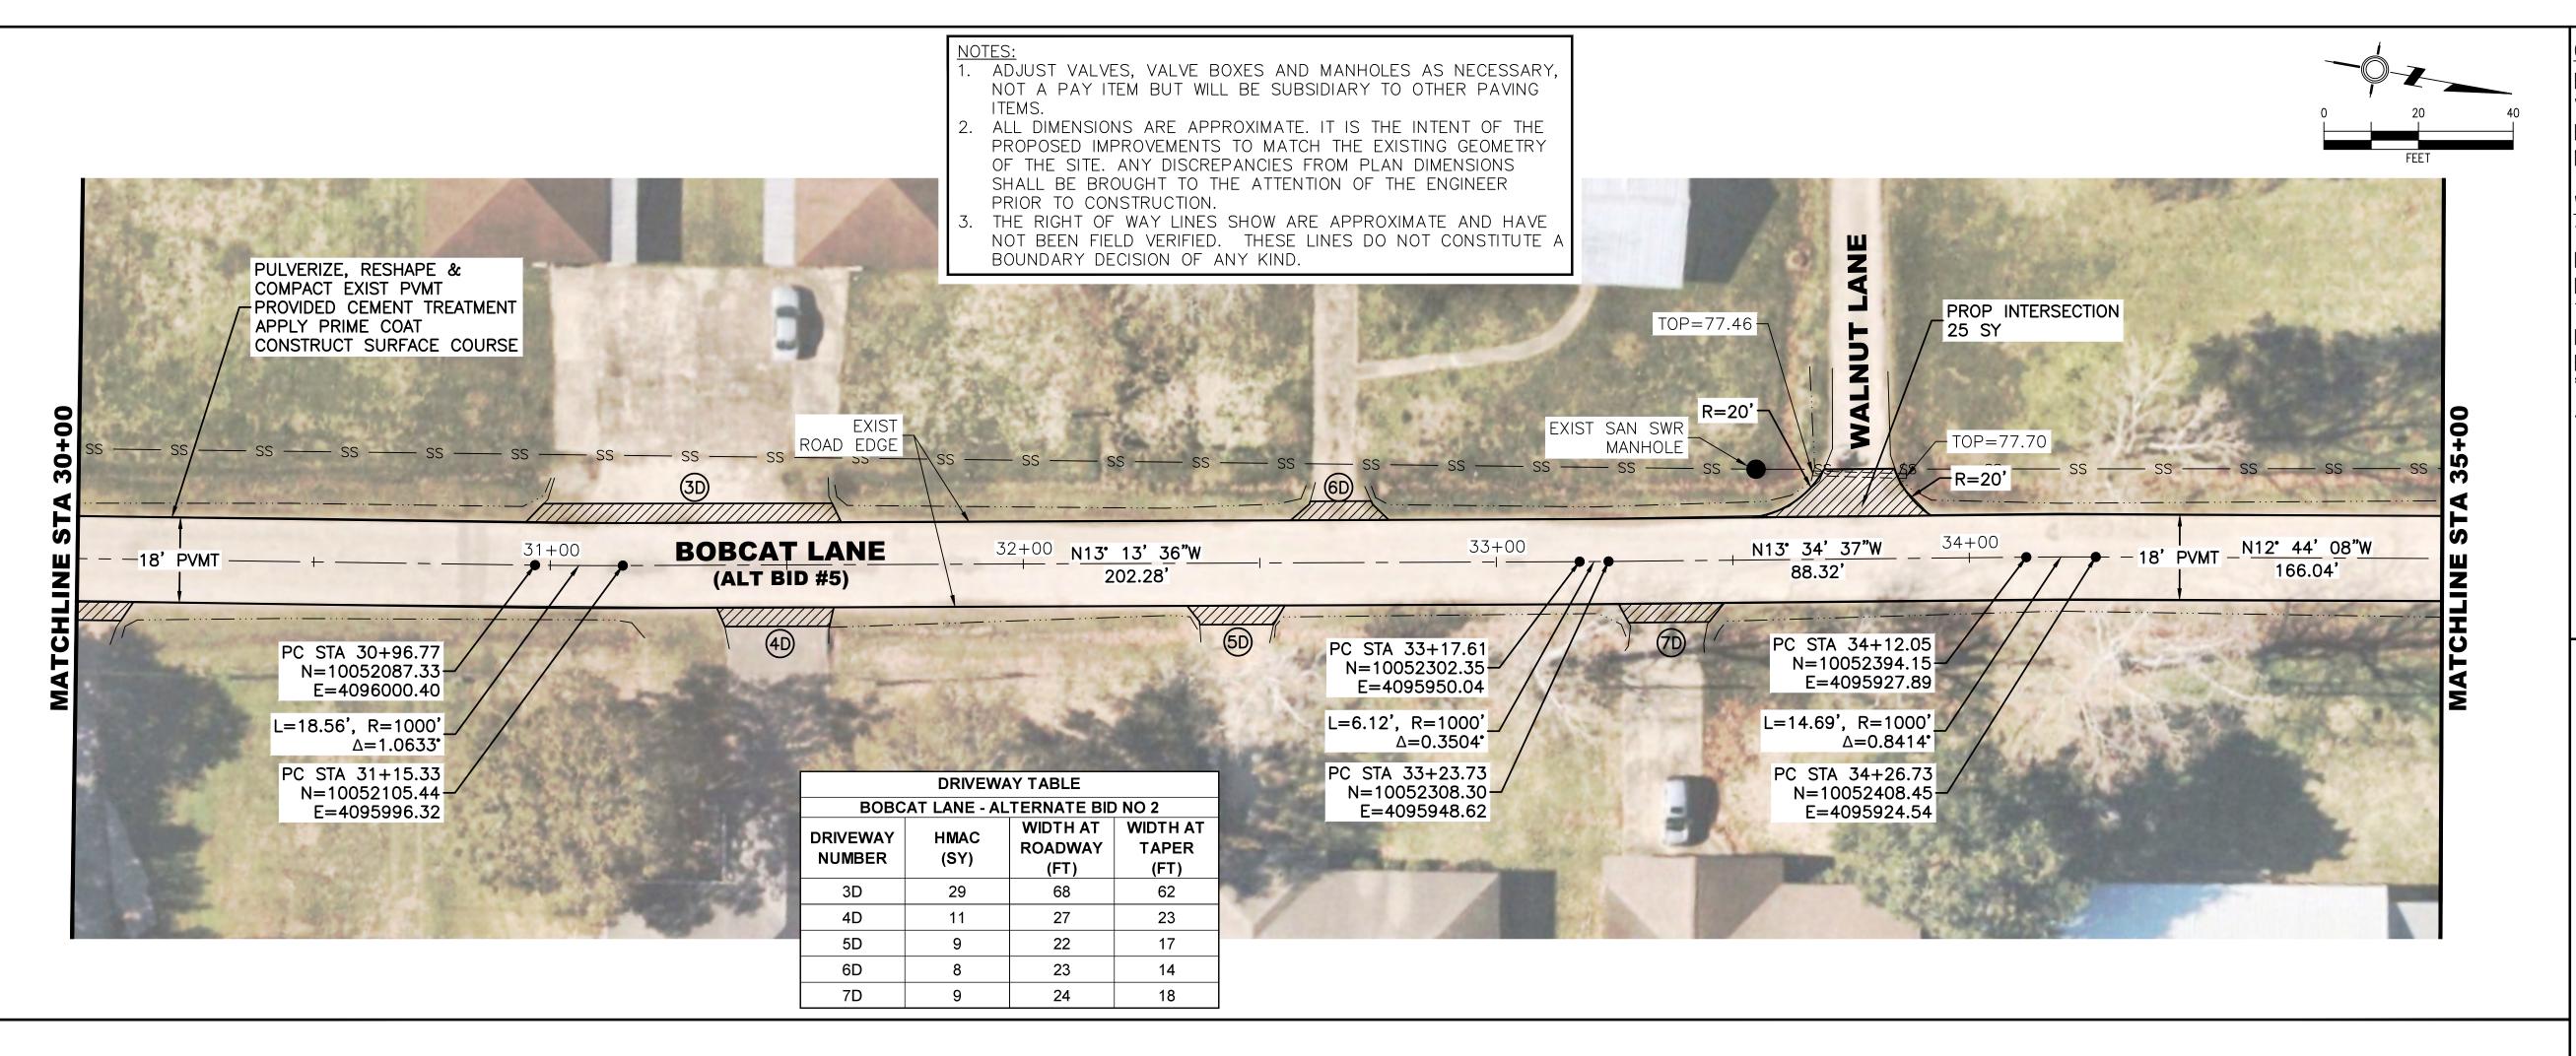



EXISTING OVERHEAD UTILITIES IN VICINITY. CONTRACTOR SHALL EXERCISE EXTREME CAUTION WHEN WORKING NEAR ELECTRICAL FACILITIES.

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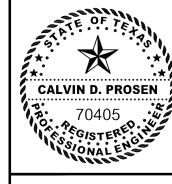


LEGEND:

● CO	SAN SWR CLEANOUT
—— ss ——	SAN SWR LINE
W	WATER METER
\bowtie	WATER VALVE
G	GAS METER
	TELEPHONE PEDESTA
TB	TELECOMMUNICATIONS &
PB	PULL BOX
JB	JUNCTION BOX
	SIGN


— w —— WATER LINE

------ EXISTING DITCH TOP



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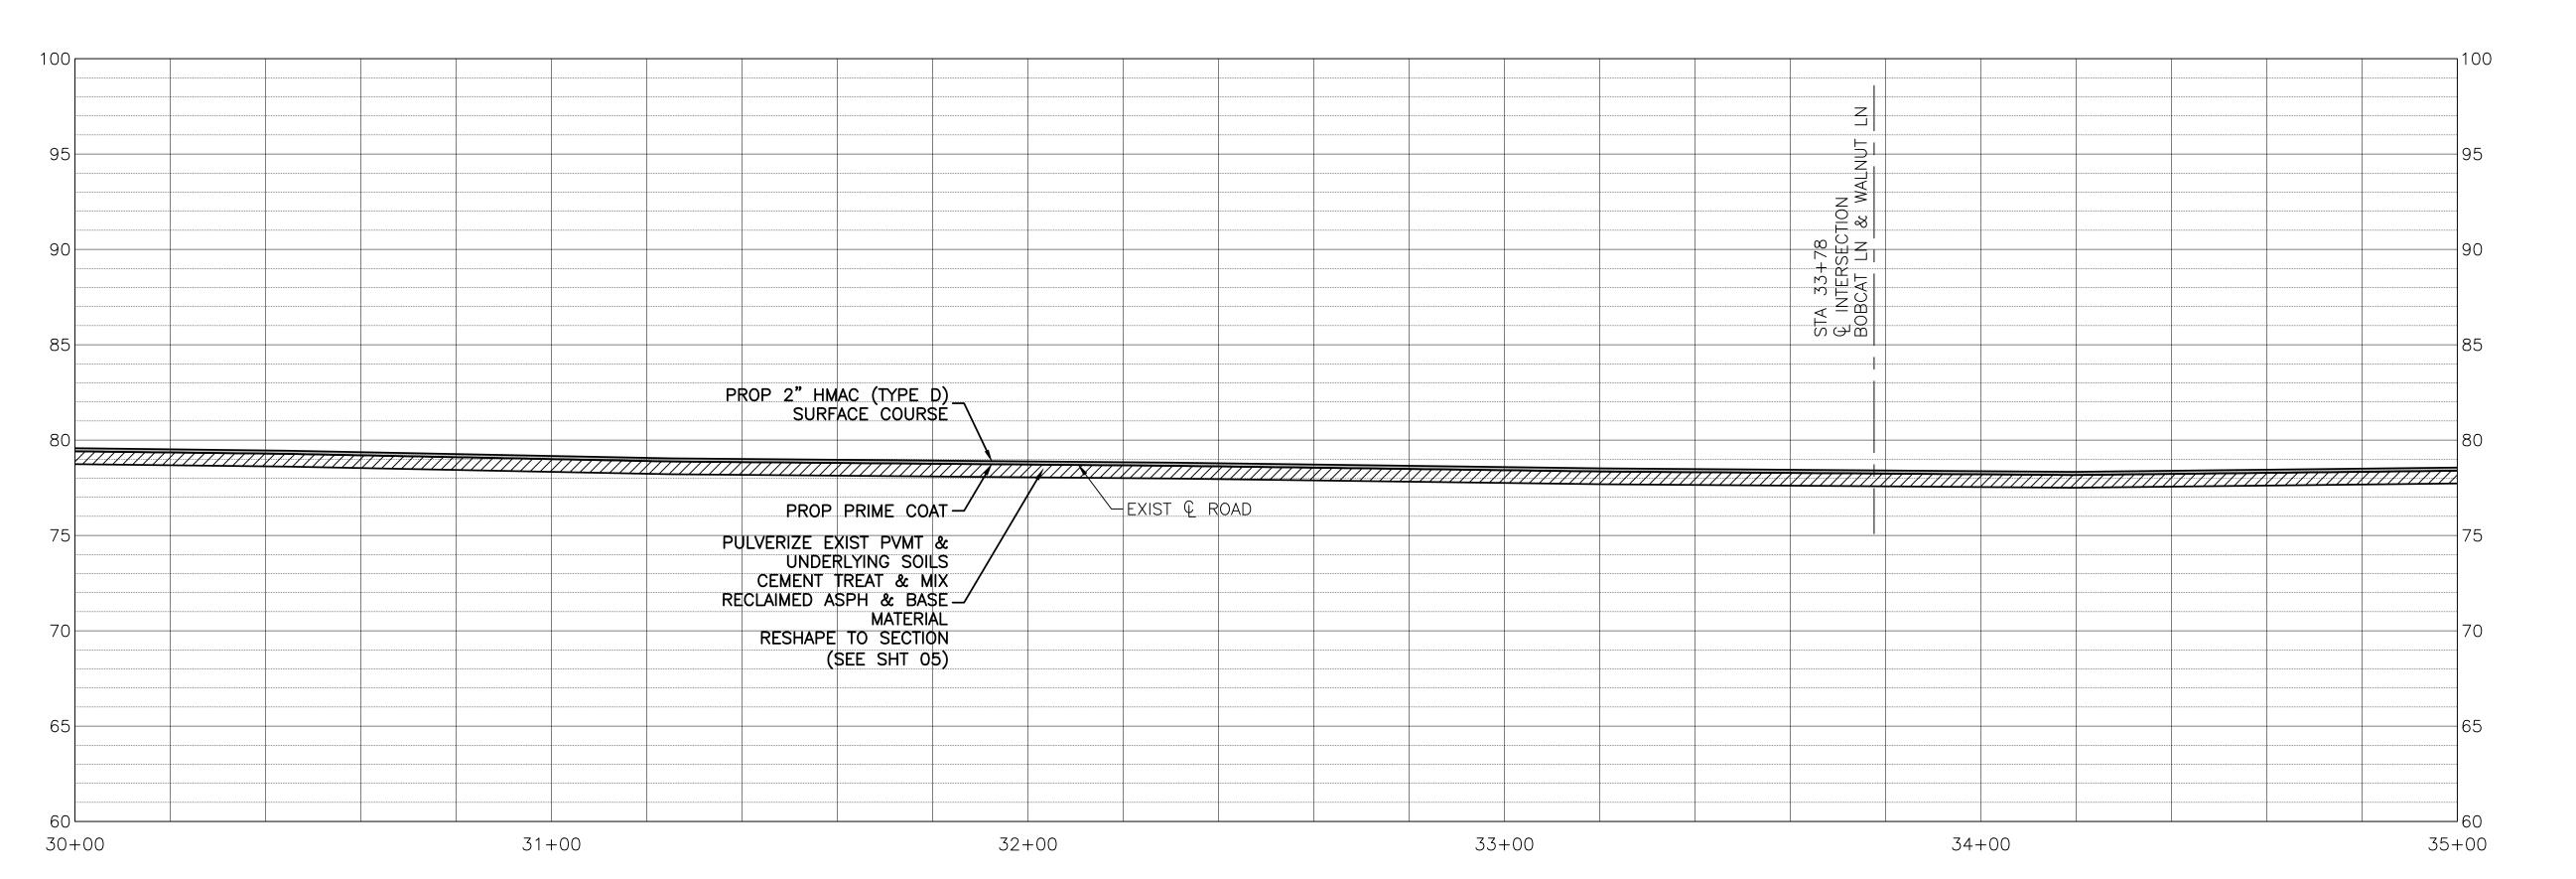
CITY OF DAISETTA, TEXAS ROAD REHABILITATION PROJECT


BOBCAT LANE ALTERNATE BID NO 5 STA 30+00 - STA 35+00

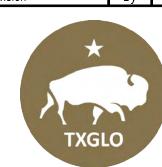
LJA Engineering, Inc.
2615 Calder Avenue, Suite 500
Beaumont, Texas 77702

Fax 409.833.0317 FRN - F-1386

DESIGN: T.G.	JOB NO.: B1246-1004
DRAWN: B.D.S.	DATE: JULY 2024
CHECKED: T.G.	SCALE: HOR.:1"=20', VERT.:1"=5'
APPROVED: C.D.P.	SHEET NO. 16 OF 28



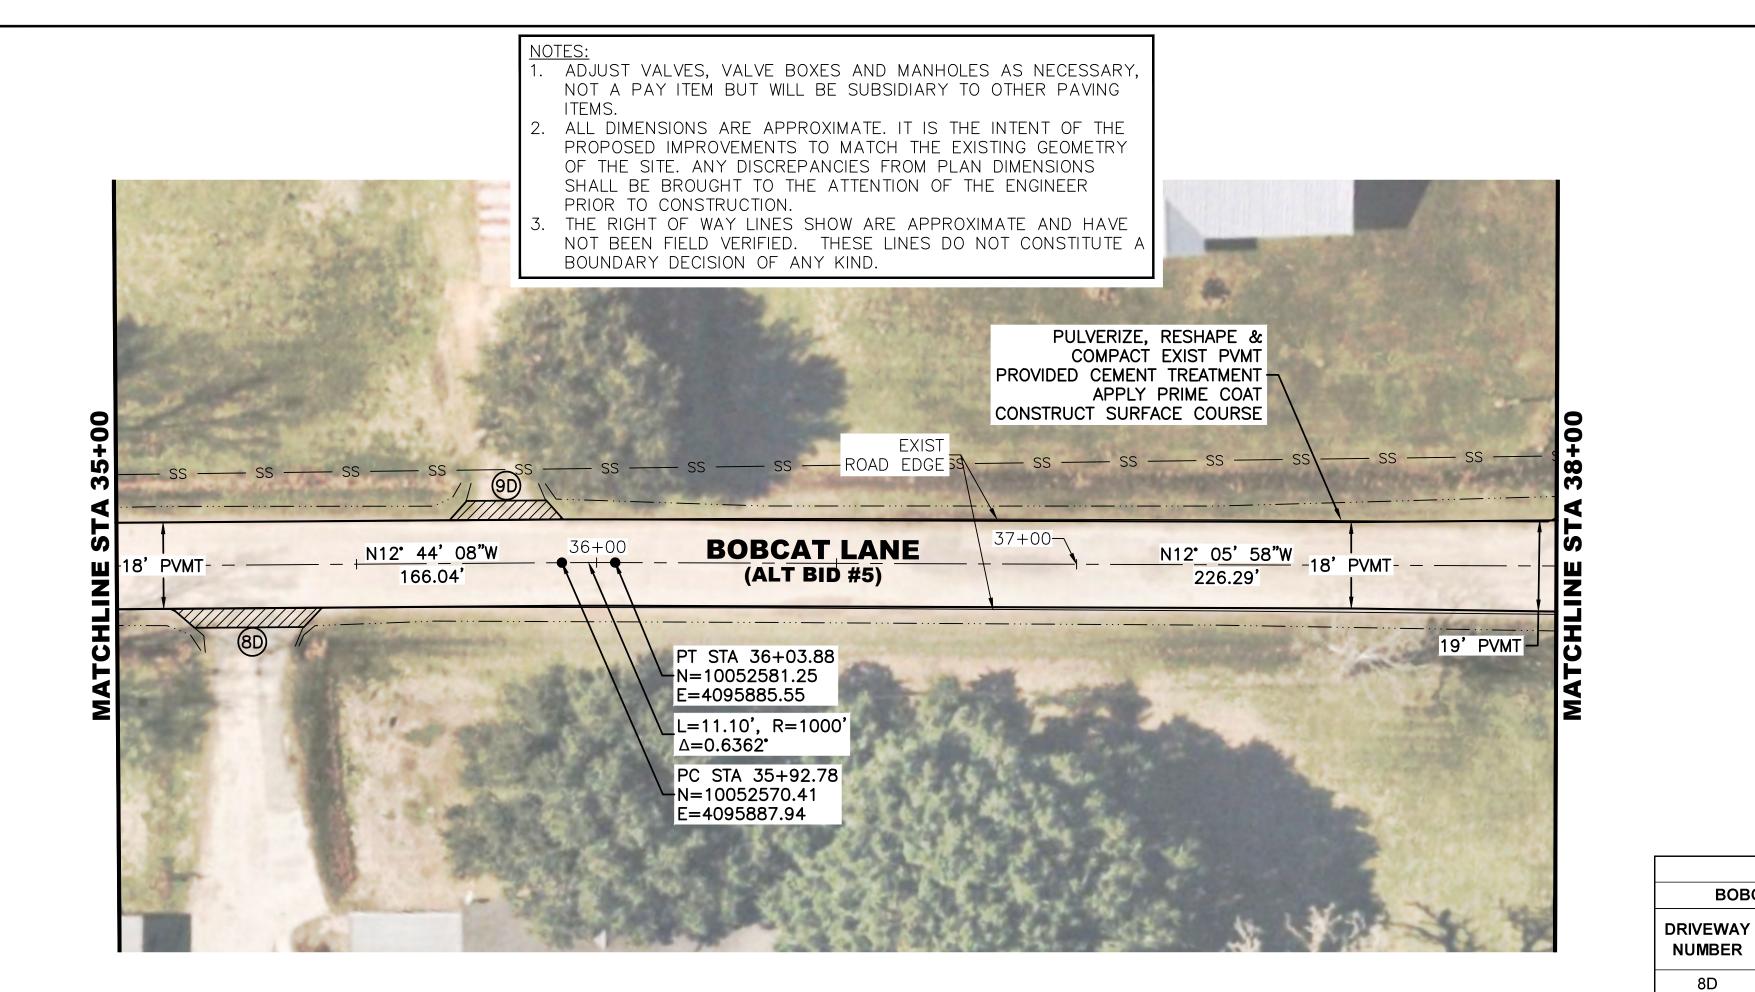

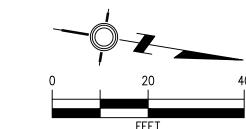

DRIVEWAY TABLE **BOBCAT LANE - ALTERNATE BID NO 2**

13

10

9D

WIDTH AT | WIDTH AT

ROADWAY

(FT)

33

25

TAPER

(FT) 25

18

<u>CAUTION</u>

EXISTING OVERHEAD UTILITIES IN VICINITY. CONTRACTOR SHALL EXERCISE EXTREME CAUTION WHEN WORKING NEAR ELECTRICAL FACILITIES.

WARNING

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LEGEND:

CO	SAN SWR CLEANOUT
ss	SAN SWR LINE
W	WATER METER
\bowtie	WATER VALVE
G	GAS METER
	TELEPHONE PEDESTAL
TB	TELECOMMUNICATIONS BO
PB	PULL BOX
JB	JUNCTION BOX
	SIGN

---- w ---- Water line

——···— EXISTING DITCH TOP



THIS DOCUMENT WAS AUTHORIZED BY CALVIN D. PROSEN, P.E. #70405, on

Revision By Chk. Appr. Date



CITY OF DAISETTA, TEXAS **ROAD REHABILITATION PROJECT**


> **BOBCAT LANE ALTERNATE BID NO 5** STA 35+00 - STA 38+00


LJA Engineering, Inc. 2615 Calder Avenue, Suite 500

Beaumont, Texas 77702

Fax 409.833.031 FRN - F-1386

SIGN: T.G.	JOB NO.: B1246-1004
AWN: B.D.S.	DATE: JULY 2024
ECKED: T.G.	SCALE: HOR.:1"=20', VERT.:1"=5'
PROVED: C.D.P.	SHEET NO. 17 OF 28

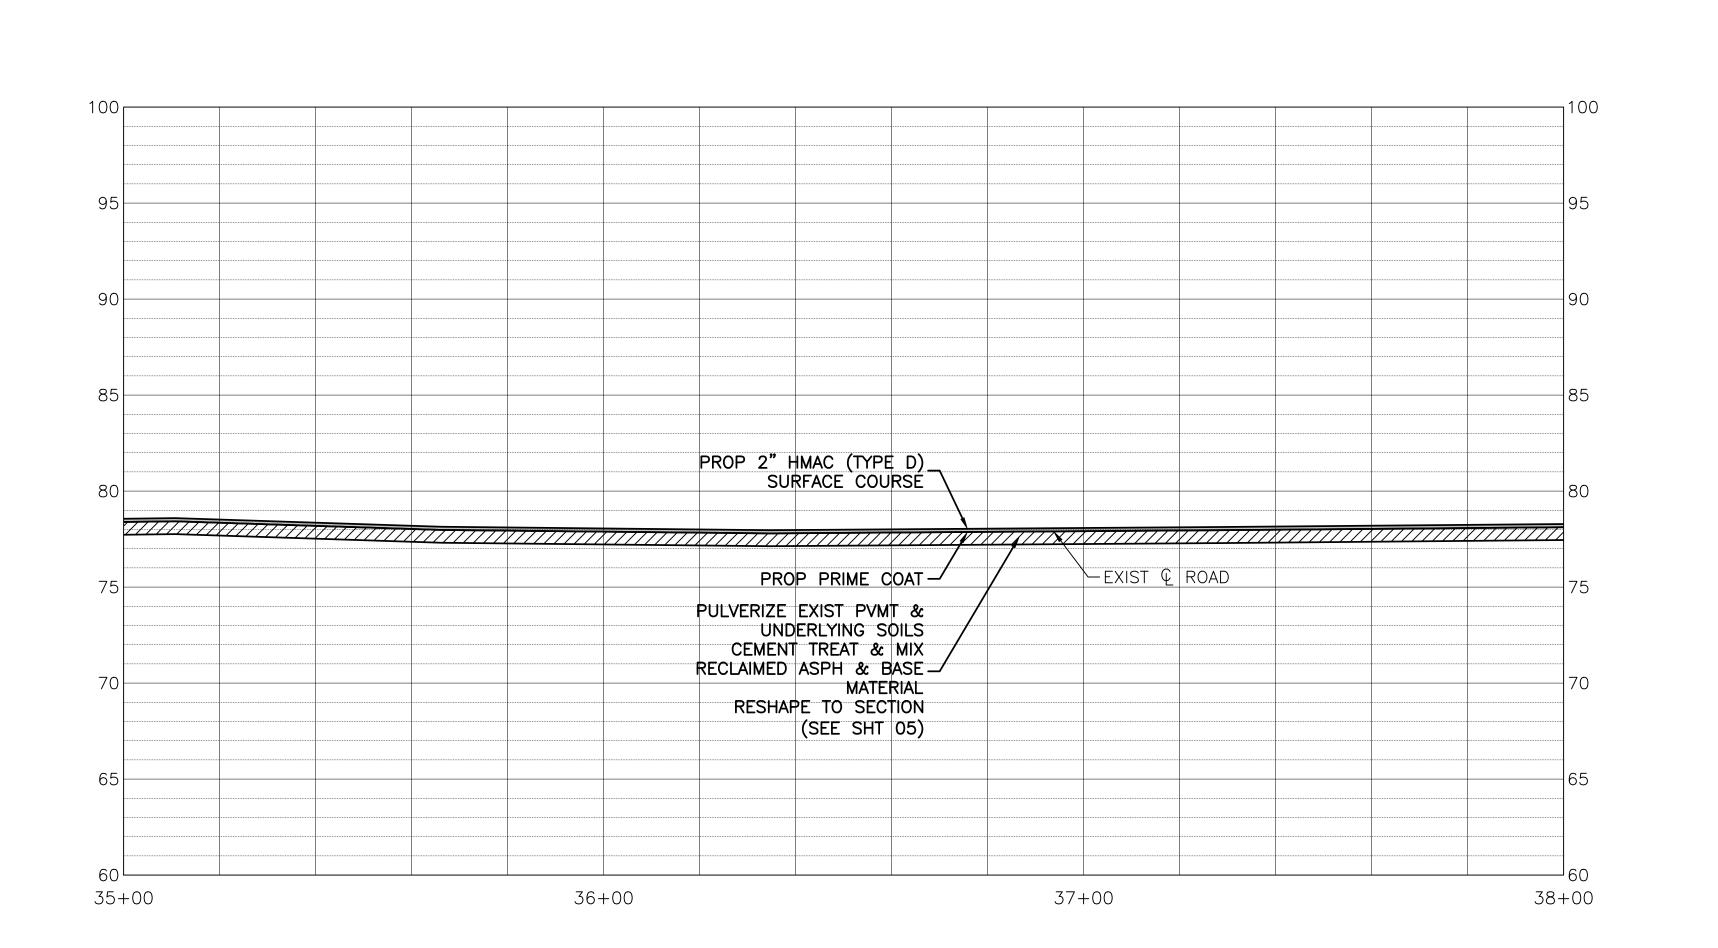

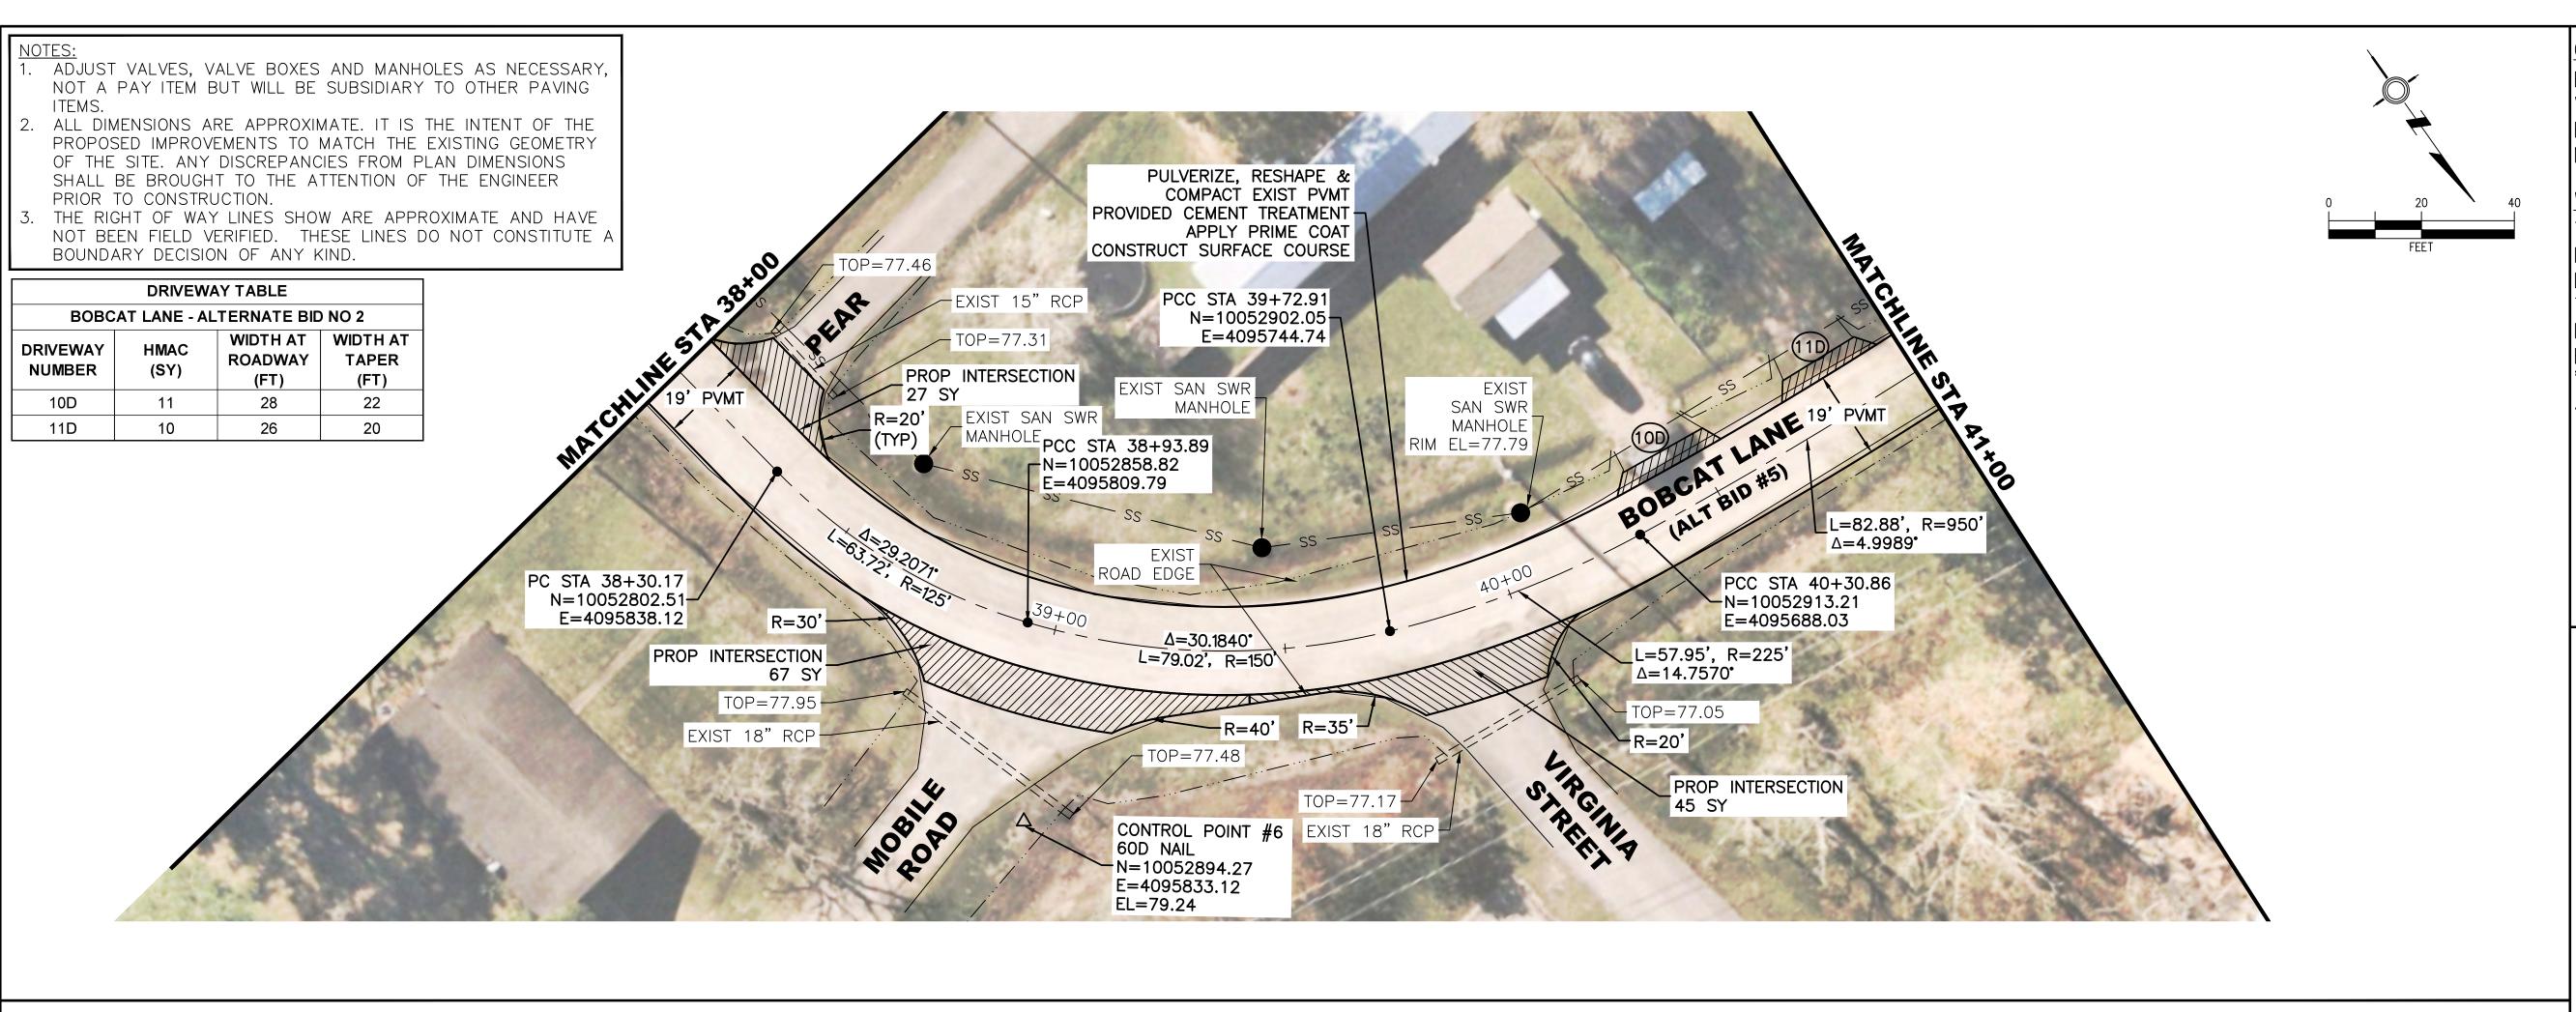

STA 39+0 C INTERS BOBCAT I PROP 2" HMAC (TYPE D) SURFACE COURSÉ `—EXI\$T € ROAD PROP PRIME COAT-PULVERIZE EXIST PVMT & UNDERLYING SOILS CEMENT TREAT & MIX RECLAIMED ASPH & BASE -MATERIAL RESHAPE TO SECTION (SEE SHT 05) 38+00 39+00 40+00 41+00

CAUTION

EXISTING OVERHEAD UTILITIES IN VICINITY. CONTRACTOR SHALL EXERCISE EXTREME CAUTION WHEN WORKING NEAR ELECTRICAL FACILITIES.

WARNING

THE ENGINEER ASSUMES NO RESPONS-IBILITY FOR THE ACCURACY OF THE LOCATION OF UNDERGROUND UTILITIES. THE CONTRACTOR SHALL BE RESPONS-IBLE FOR LOCATION AND AVOIDING ALL EXISTING UTILITIES BY CALLING THE "ONE CALL" LOCATOR SERVICE AT LEAST 48 HOURS PRIOR TO CONSTRUCTION.



——···— EXISTING DITCH TOP

LEGEND:

• CO	SAN SWR CLEANOUT
ss	SAN SWR LINE
W	WATER METER
\bowtie	WATER VALVE
G	GAS METER
	TELEPHONE PEDESTAL
TB	TELECOMMUNICATIONS BOX
PB	PULL BOX
JB	JUNCTION BOX
	SIGN

---- W ----- WATER LINE



THE SEAL APPEARING ON THIS DOCUMENT WAS AUTHORIZED BY CALVIN D. PROSEN, P.E. #70405, on

By Chk. Appr. Date Revision



CITY OF DAISETTA, TEXAS **ROAD REHABILITATION PROJECT**

> **BOBCAT LANE ALTERNATE BID NO 5** STA 38+00 - STA 41+00

LJA Engineering, Inc. 2615 Calder Avenue, Suite 500

Beaumont, Texas 77702

FRN - F-138

Fax 409.833.031


DESIGN: T.G. JOB NO.: B1246-1004 DATE: JULY 2024 DRAWN: B.D.S. CHECKED: T.G. SCALE: HOR.: 1"=20', VERT.: 1"=5' APPROVED: C.D.P. SHEET NO. 18 OF 28

NOTES:

. ADJUST VALVES, VALVE BOXES AND MANHOLES AS NECESSARY, NOT A PAY ITEM BUT WILL BE SUBSIDIARY TO OTHER PAVING ITEMS.

2. ALL DIMENSIONS ARE APPROXIMATE. IT IS THE INTENT OF THE PROPOSED IMPROVEMENTS TO MATCH THE EXISTING GEOMETRY OF THE SITE. ANY DISCREPANCIES FROM PLAN DIMENSIONS SHALL BE BROUGHT TO THE ATTENTION OF THE ENGINEER PRIOR TO CONSTRUCTION.

3. THE RIGHT OF WAY LINES SHOW ARE APPROXIMATE AND HAVE NOT BEEN FIELD VERIFIED. THESE LINES DO NOT CONSTITUTE A BOUNDARY DECISION OF ANY KIND.

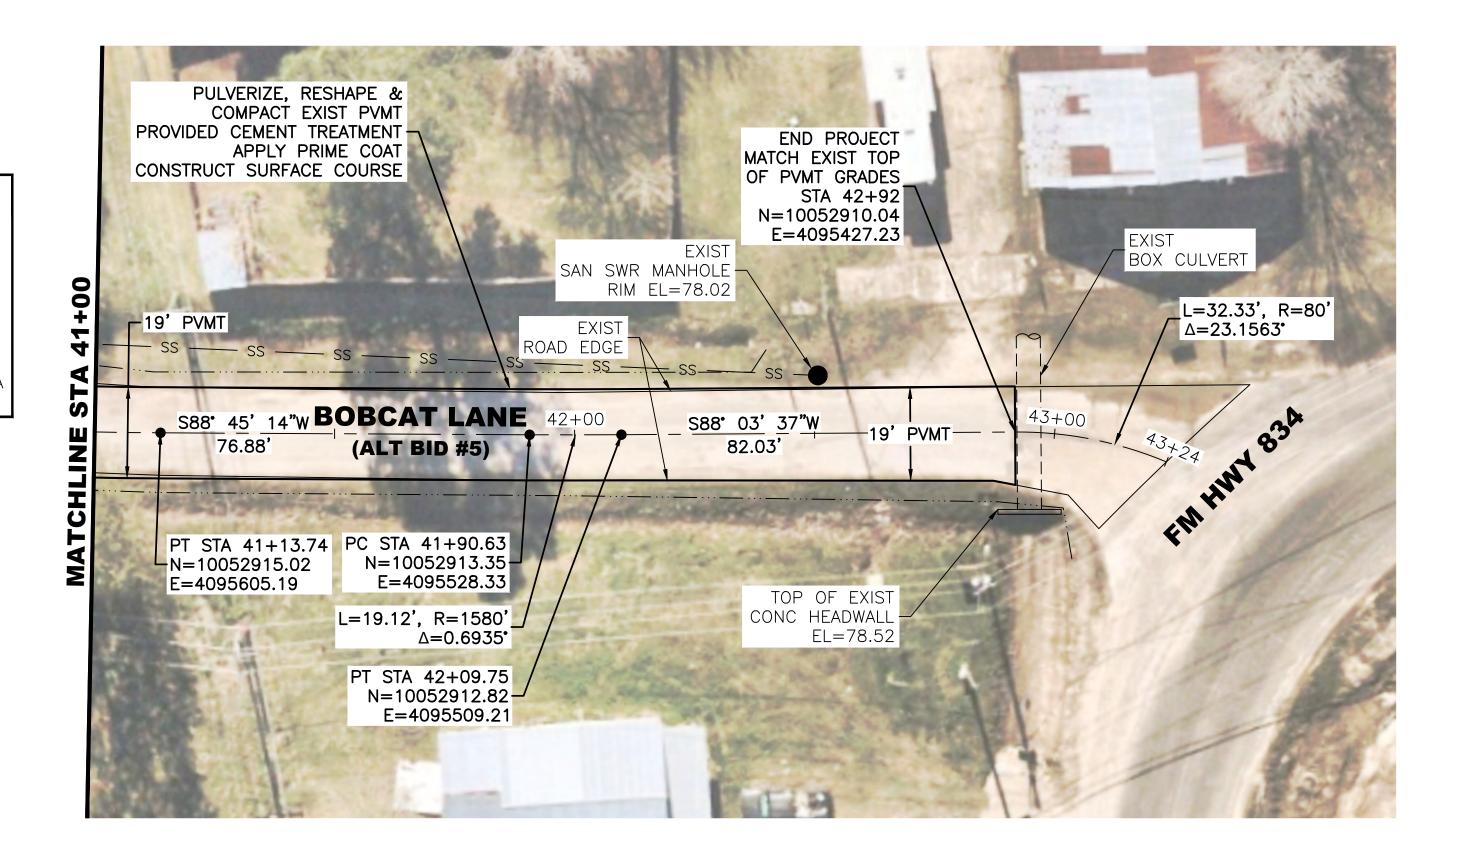

<u>CAUTION</u>

EXISTING OVERHEAD UTILITIES IN VICINITY. CONTRACTOR SHALL EXERCISE EXTREME CAUTION WHEN WORKING NEAR ELECTRICAL FACILITIES.

<u>WARNING</u>

THE ENGINEER ASSUMES NO RESPONS—IBILITY FOR THE ACCURACY OF THE LOCATION OF UNDERGROUND UTILITIES.
THE CONTRACTOR SHALL BE RESPONS—IBLE FOR LOCATION AND AVOIDING ALL EXISTING UTILITIES BY CALLING THE "ONE CALL" LOCATOR SERVICE AT LEAST 48 HOURS PRIOR TO CONSTRUCTION.




____ ... _ EXISTING DITCH TOP

LEGEND:

● CO	SAN SWR CLEANOUT
ss	SAN SWR LINE
W	WATER METER
\bowtie	WATER VALVE
G	GAS METER
	TELEPHONE PEDESTAL
TB	TELECOMMUNICATIONS BOX
PB	PULL BOX
JB	JUNCTION BOX
	SIGN

---- W ---- WATER LINE

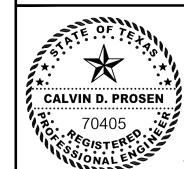

Revision

THE SEAL APPEARING ON THIS DOCUMENT WAS AUTHORIZED BY CALVIN D. PROSEN, P.E. #70405, on Jul 31, 2024

By Chk. Appr. Date

*

CITY OF DAISETTA, TEXAS
ROAD REHABILITATION PROJECT


BOBCAT LANE ALTERNATE BID NO 5 STA 41+00 - STA 43+24


LJA Engineering, Inc. 2615 Calder Avenue, Suite 500

2615 Calder Avenue, Suite 500 Phone 409.833.3363
Beaumont, Texas 77702 Fax 409.833.0313
FRN - F-1386

DESIGN: T.G. JOB NO.: B1246-1004

DESIGN: T.G.	JOB NO.: B1246-1004
DRAWN: B.D.S.	DATE: JULY 2024
CHECKED: T.G.	SCALE: HOR.:1"=20', VERT.:1"=5'
APPROVED: C.D.P.	SHEET NO. 19 OF 28

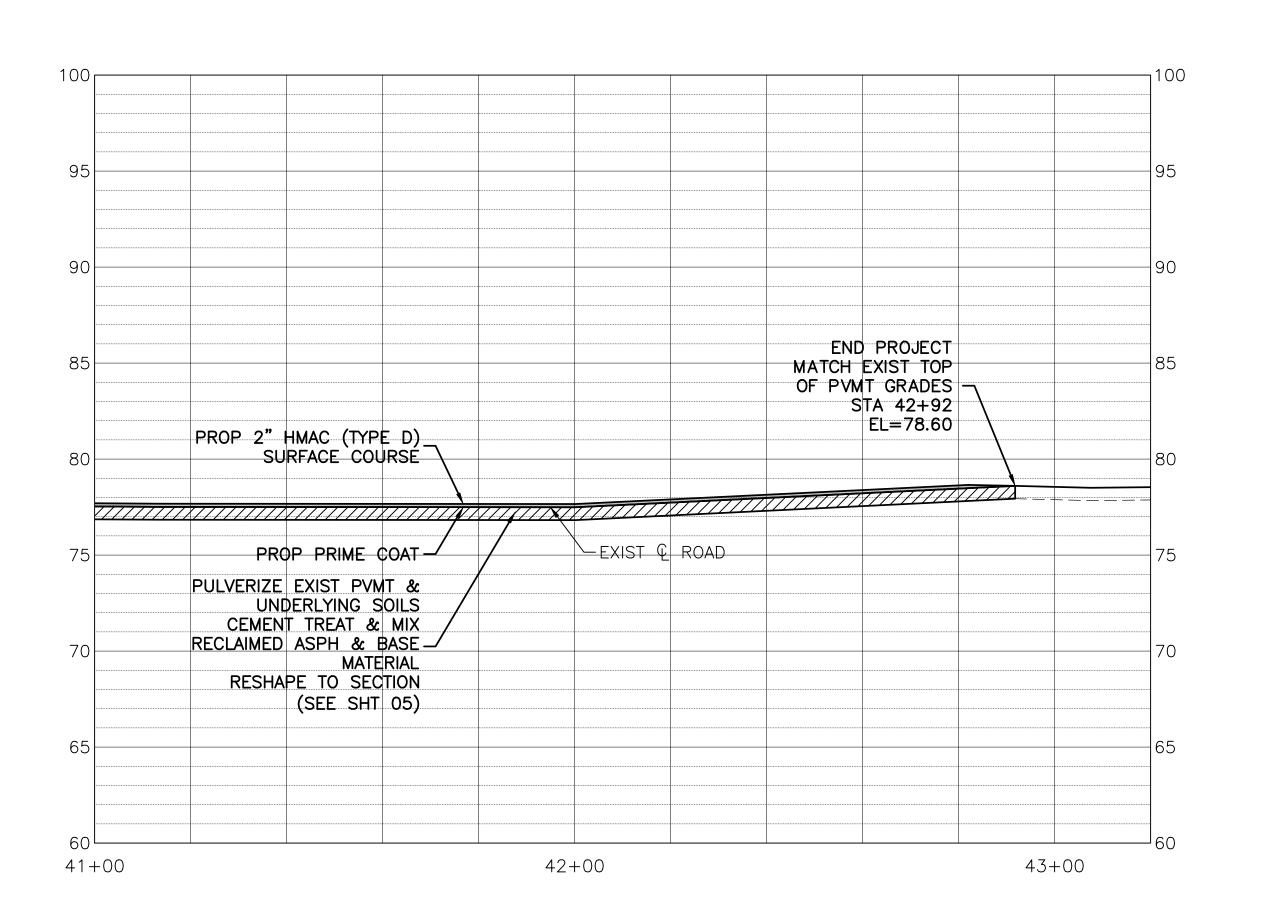

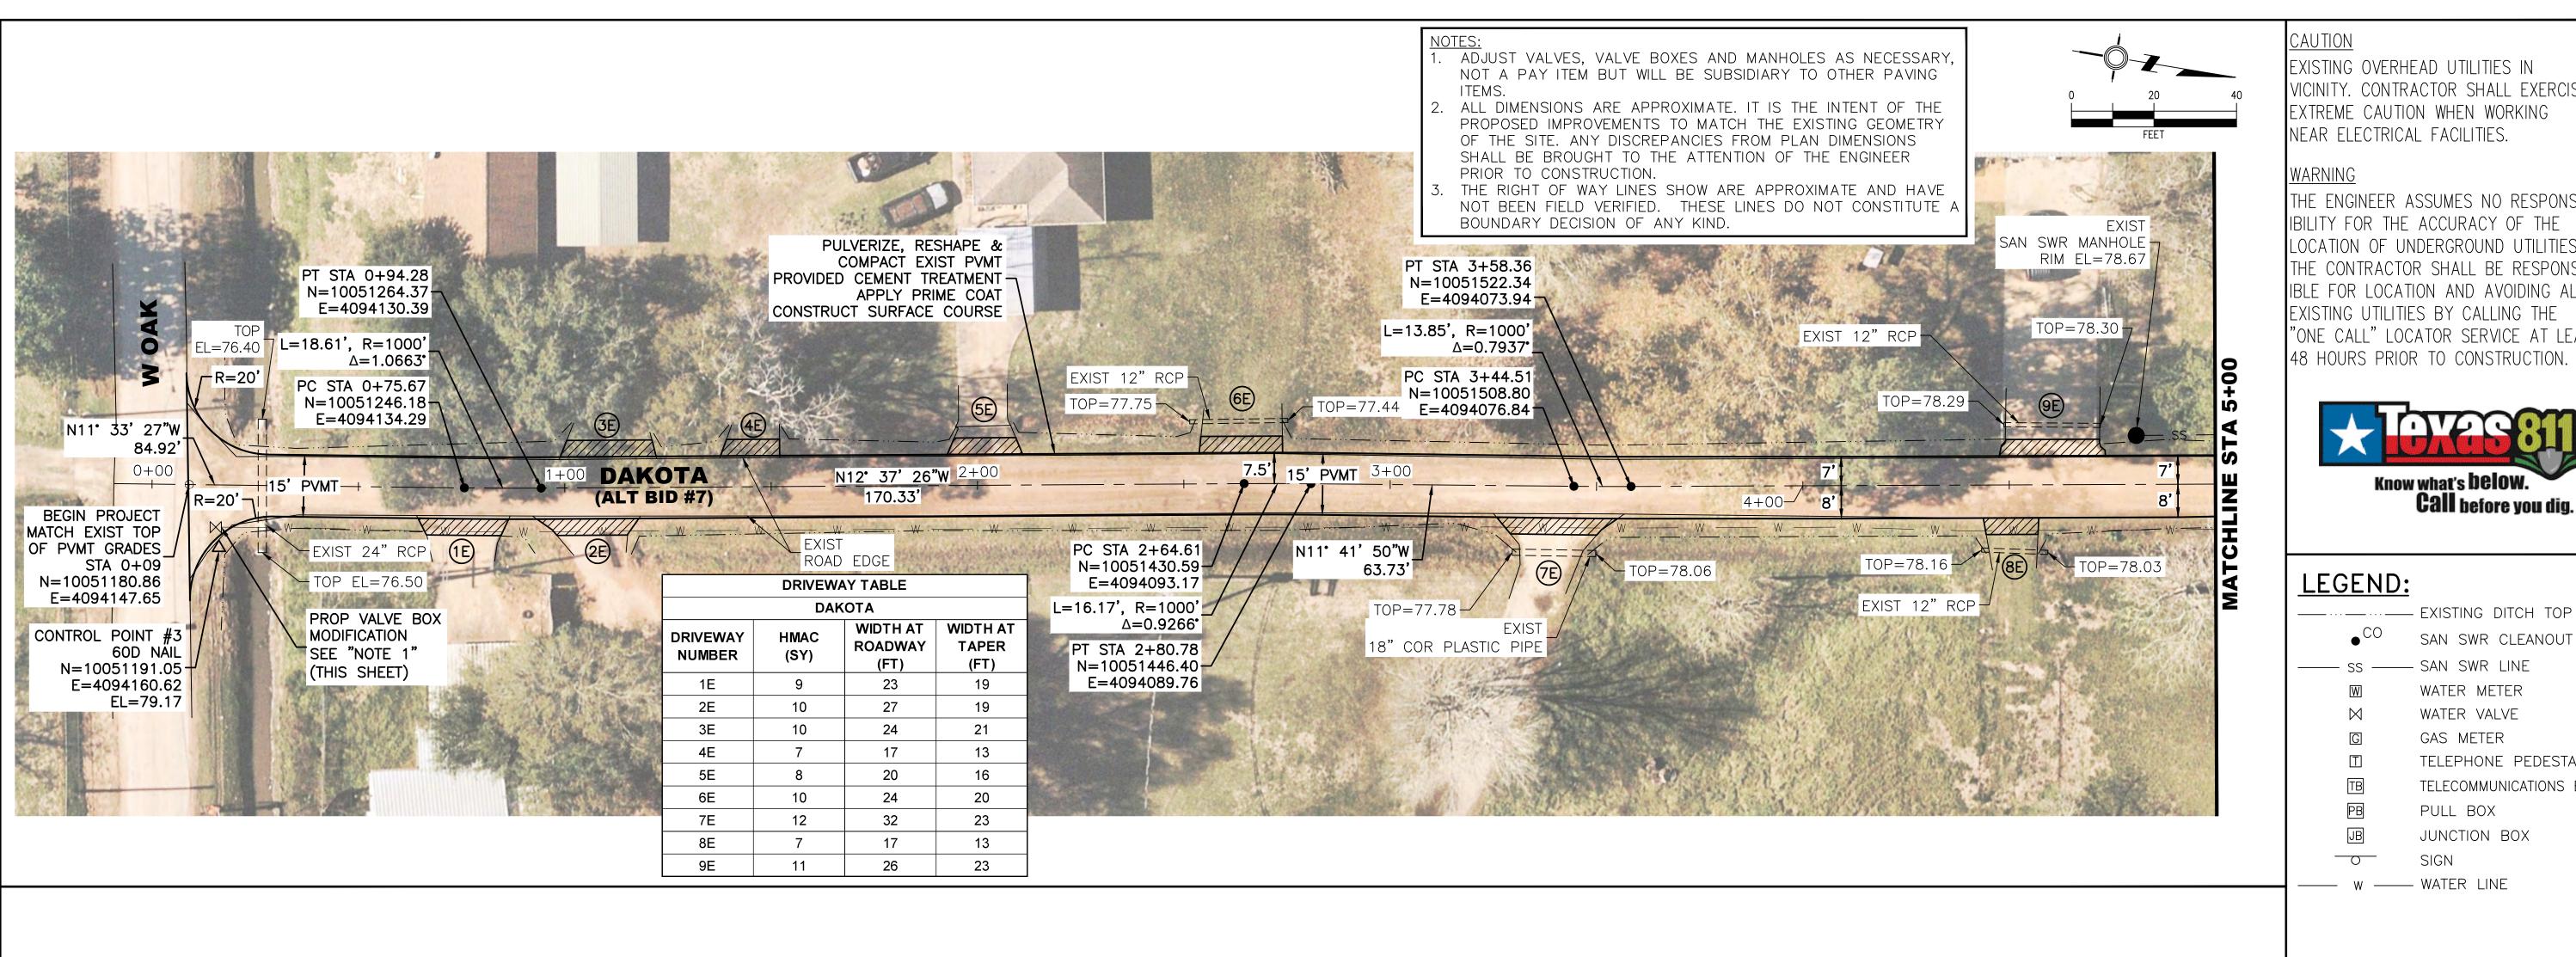

CAUTION

EXISTING OVERHEAD UTILITIES IN VICINITY. CONTRACTOR SHALL EXERCISE EXTREME CAUTION WHEN WORKING NEAR ELECTRICAL FACILITIES.

WARNING

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SAN SWR CLEANOUT

LEGEND:

- ss ---- SAN SWR LINE WATER METER WATER VALVE GAS METER TELEPHONE PEDESTAL TELECOMMUNICATIONS BOX PULL BOX JB JUNCTION BOX $\overline{}$

w ---- WATER LINE



THIS DOCUMENT WAS

By Chk. Appr. Date Revision



CITY OF DAISETTA, TEXAS **ROAD REHABILITATION PROJECT**


> **DAKOTA ALTERNATE BID NO 7** STA 0+00 - STA 5+00


LJA Engineering, Inc. 2615 Calder Avenue, Suite 500

Beaumont, Texas 77702 Fax 409.833.031

DESIGN: T.G. JOB NO.: B1246-1004 DATE: JULY 2024 DRAWN: B.D.S. SCALE: HOR.: 1"=20', VERT.: 1"=5' CHECKED: T.G. APPROVED: C.D.P. SHEET NO. 20 OF 28

FRN - F-138

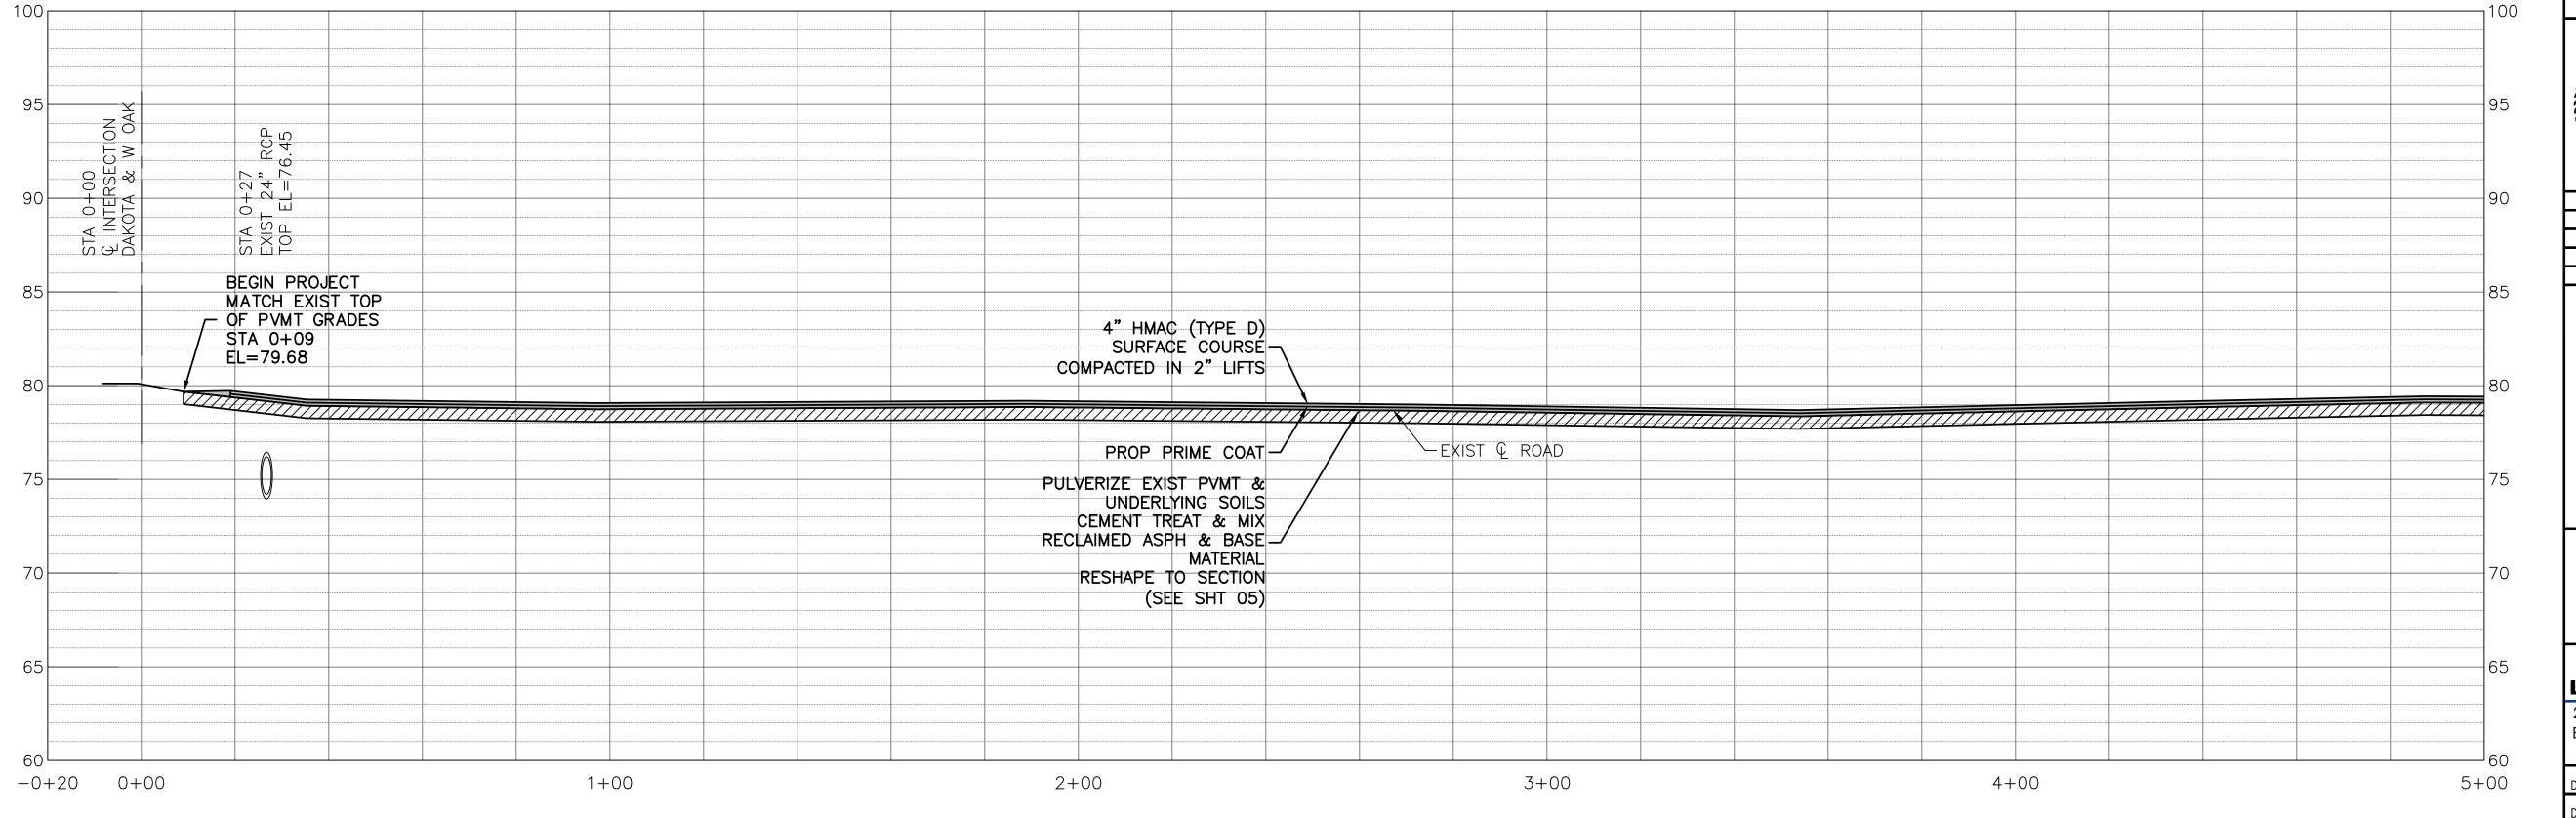

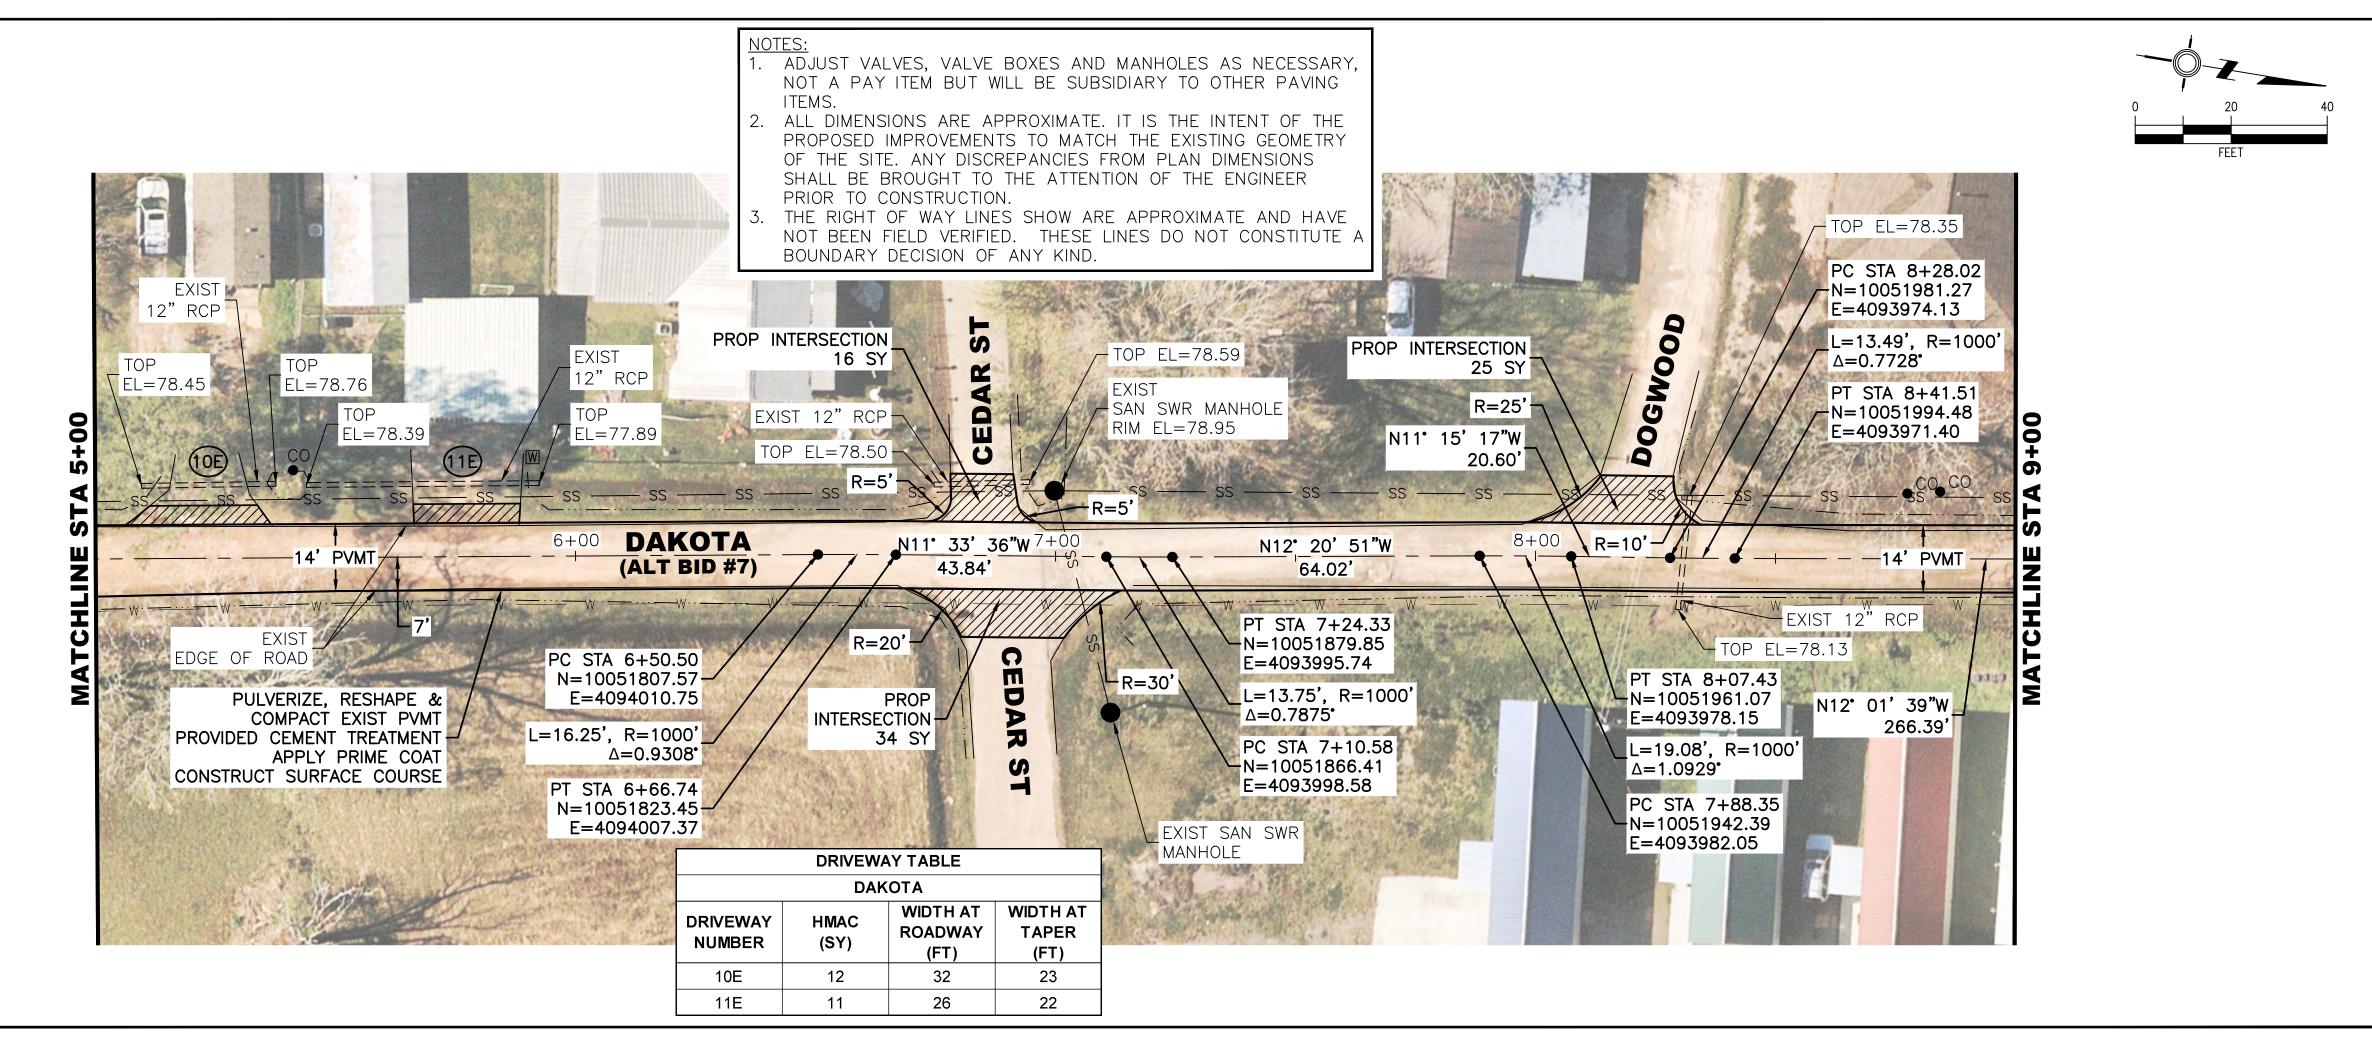

<u>CAUTION</u>

EXISTING OVERHEAD UTILITIES IN VICINITY. CONTRACTOR SHALL EXERCISE EXTREME CAUTION WHEN WORKING NEAR ELECTRICAL FACILITIES.

WARNING

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LEGEND:

● CO	SAN SWR CLEANOUT
—— ss ——	SAN SWR LINE
W	WATER METER
\bowtie	WATER VALVE
G	GAS METER
	TELEPHONE PEDESTAL
TB	TELECOMMUNICATIONS BOX
PB	PULL BOX
JB	JUNCTION BOX
	SIGN

---- WATER LINE

— ··· — EXISTING DITCH TOP



THE SEAL APPEARING ON THIS DOCUMENT WAS AUTHORIZED BY CALVIN D. PROSEN, P.E. #70405, on Jul 31, 2024

Revision By Chk. Appr. Date




CITY OF DAISETTA, TEXAS
ROAD REHABILITATION PROJECT


DAKOTA
ALTERNATE BID NO 7
STA 5+00 - STA 9+00

LJA Engineering, Inc.
2615 Calder Avenue, Suite 500
Beaumont, Texas 77702

Fax 409.833.031 FRN - F-1380 B1246-1004


DESIGN: T.G.	JOB NO.: B1246-1004
DRAWN: B.D.S.	DATE: JULY 2024
CHECKED: T.G.	SCALE: HOR.:1"=20', VERT.:1"=5'
APPROVED: C.D.P.	SHEET NO. 21 OF 28

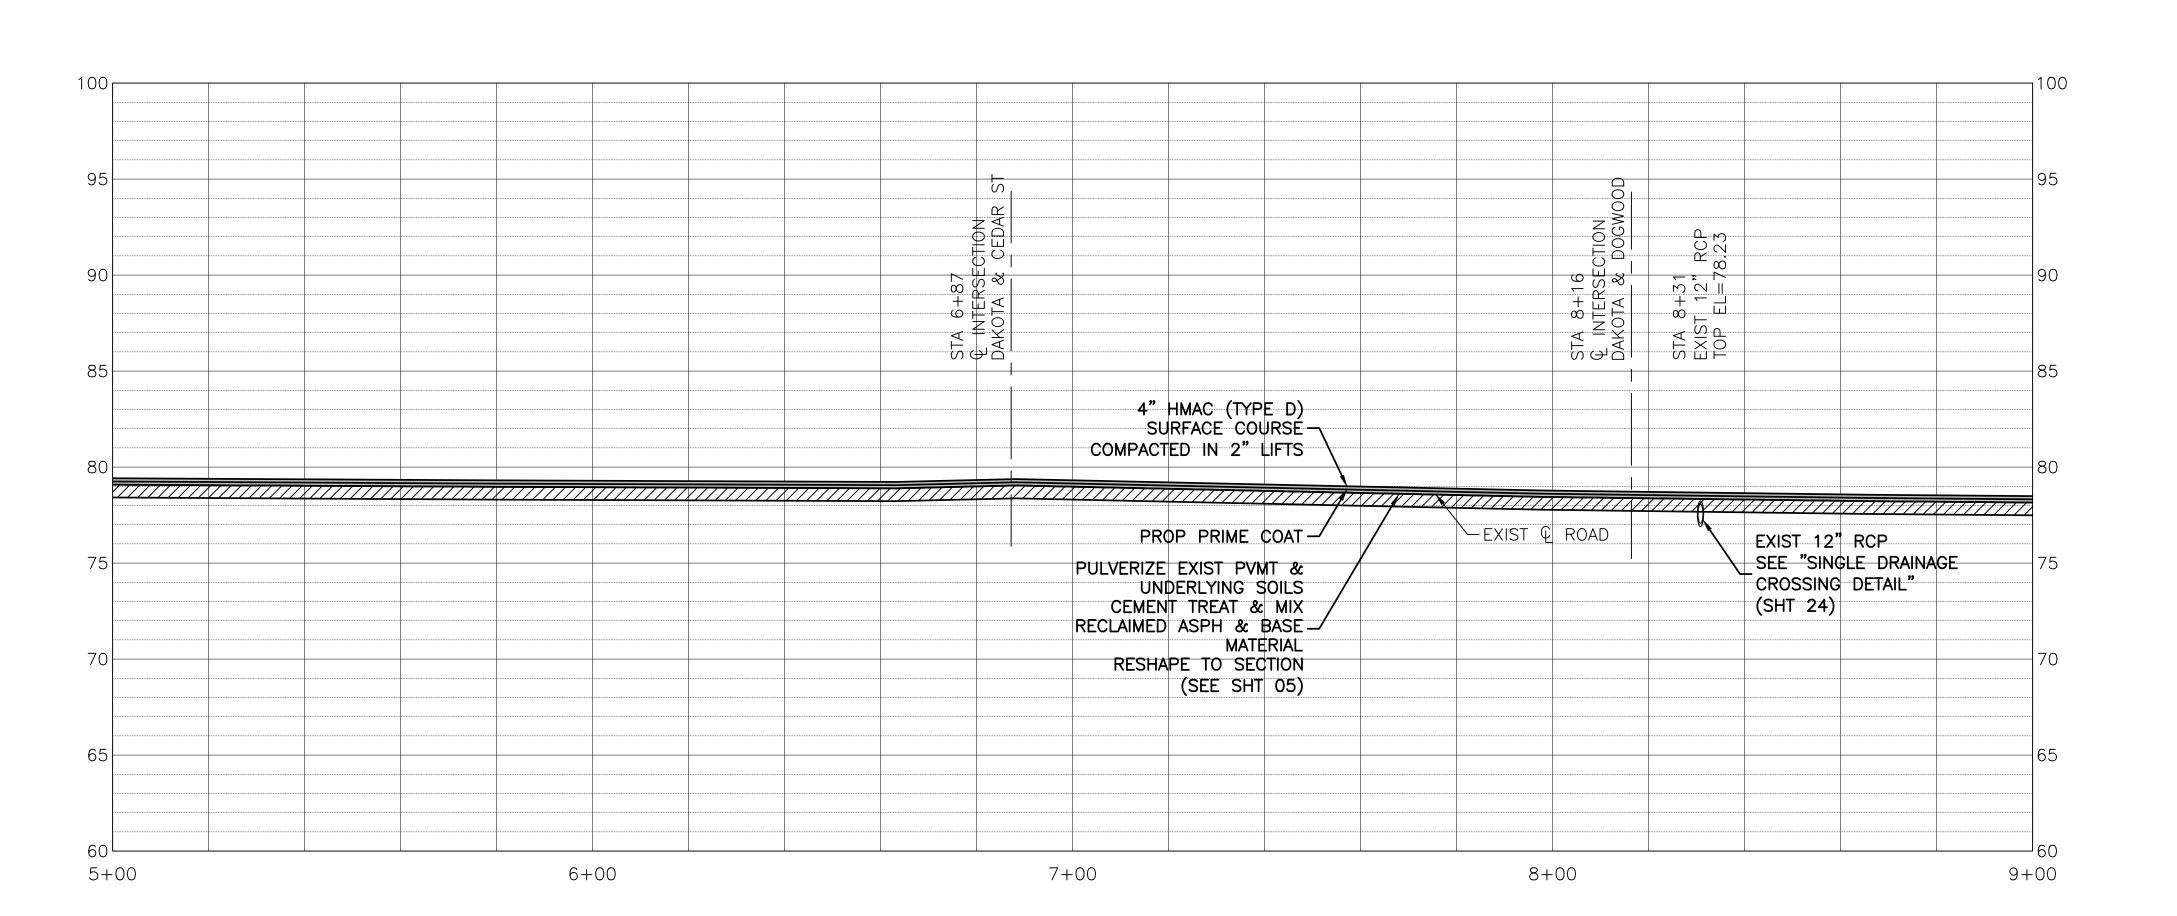

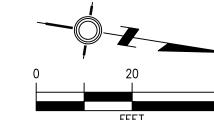

ADJUST VALVES, VALVE BOXES AND MANHOLES AS NECESSARY, NOT A PAY ITEM BUT WILL BE SUBSIDIARY TO OTHER PAVING

- ALL DIMENSIONS ARE APPROXIMATE. IT IS THE INTENT OF THE PROPOSED IMPROVEMENTS TO MATCH THE EXISTING GEOMETRY OF THE SITE. ANY DISCREPANCIES FROM PLAN DIMENSIONS SHALL BE BROUGHT TO THE ATTENTION OF THE ENGINEER PRIOR TO CONSTRUCTION.
- 3. THE RIGHT OF WAY LINES SHOW ARE APPROXIMATE AND HAVE NOT BEEN FIELD VERIFIED. THESE LINES DO NOT CONSTITUTE A BOUNDARY DECISION OF ANY KIND.

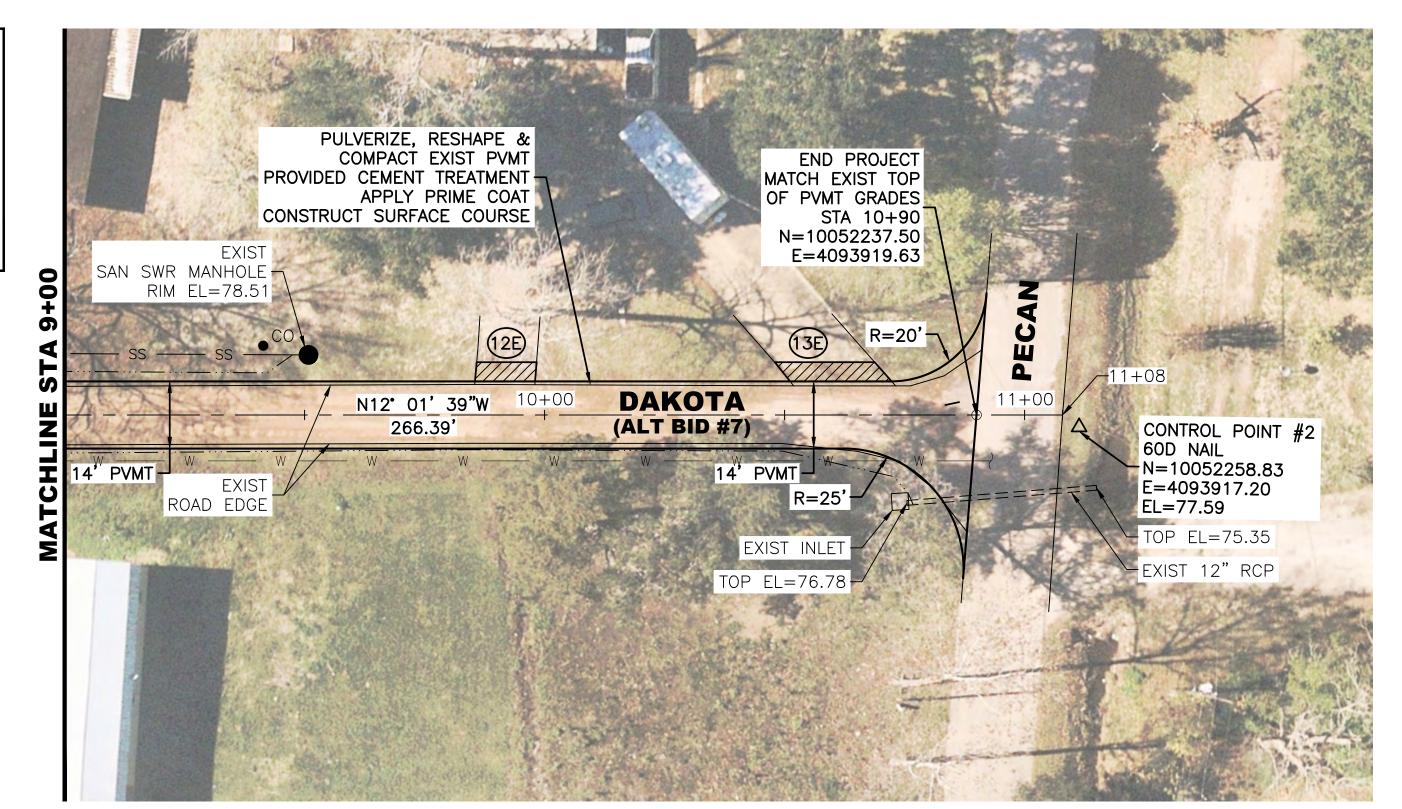

DRIVEWAY TABLE								
	DAKOTA							
DRIVEWAY NUMBER	HMAC (SY)	WIDTH AT ROADWAY (FT)	WIDTH AT TAPER (FT)					
12E	6	16	12					
13E	10	25	21					
			·					

<u>CAUTION</u>

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WARNING

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LEGEND:

● CO	SAN SWR CLEANOUT
ss	- SAN SWR LINE
W	WATER METER
\bowtie	WATER VALVE
G	GAS METER
	TELEPHONE PEDESTA
TB	TELECOMMUNICATIONS
PB	PULL BOX
JB	JUNCTION BOX
	SIGN

---- W ----- WATER LINE

----- EXISTING DITCH TOP



THIS DOCUMENT WAS AUTHORIZED BY CALVIN D. PROSEN, P.E. #70405, on

By Chk. Appr. Date Revision



CITY OF DAISETTA, TEXAS **ROAD REHABILITATION PROJECT**

> **DAKOTA ALTERNATE BID NO 7** STA 9+00 - STA 10+90


LJA Engineering, Inc. 2615 Calder Avenue, Suite 500 Beaumont, Texas 77702


FRN - F-138 JOB NO.: B1246-1004 DESIGN: T.G. DRAWN: B.D.S. DATE: JULY 2024 CHECKED: T.G. SCALE: HOR.:1"=20', VERT.:1"=5'

STA 1+99 C INTERSEC DAKOTA & END PROJECT MATCH EXIST TOP OF PVMT GRADES -STA 10+90 EL=78.01 4" HMAC (TYPE D) SURFACE COURSÉ -COMPACTED IN 2" LIFTS PROP PRIME COAT EXIST & ROAD PULVERIZE EXIST PVMT & UNDERLYING SOILS CEMENT TREAT & MIX RECLAIMED ASPH & BASE -/ MATERIAL RESHAPE TO SECTION (SEE SHT 05) 10+00 9+00 11+00

APPROVED: C.D.P. SHEET NO. 22 OF 28

Fax 409.833.031

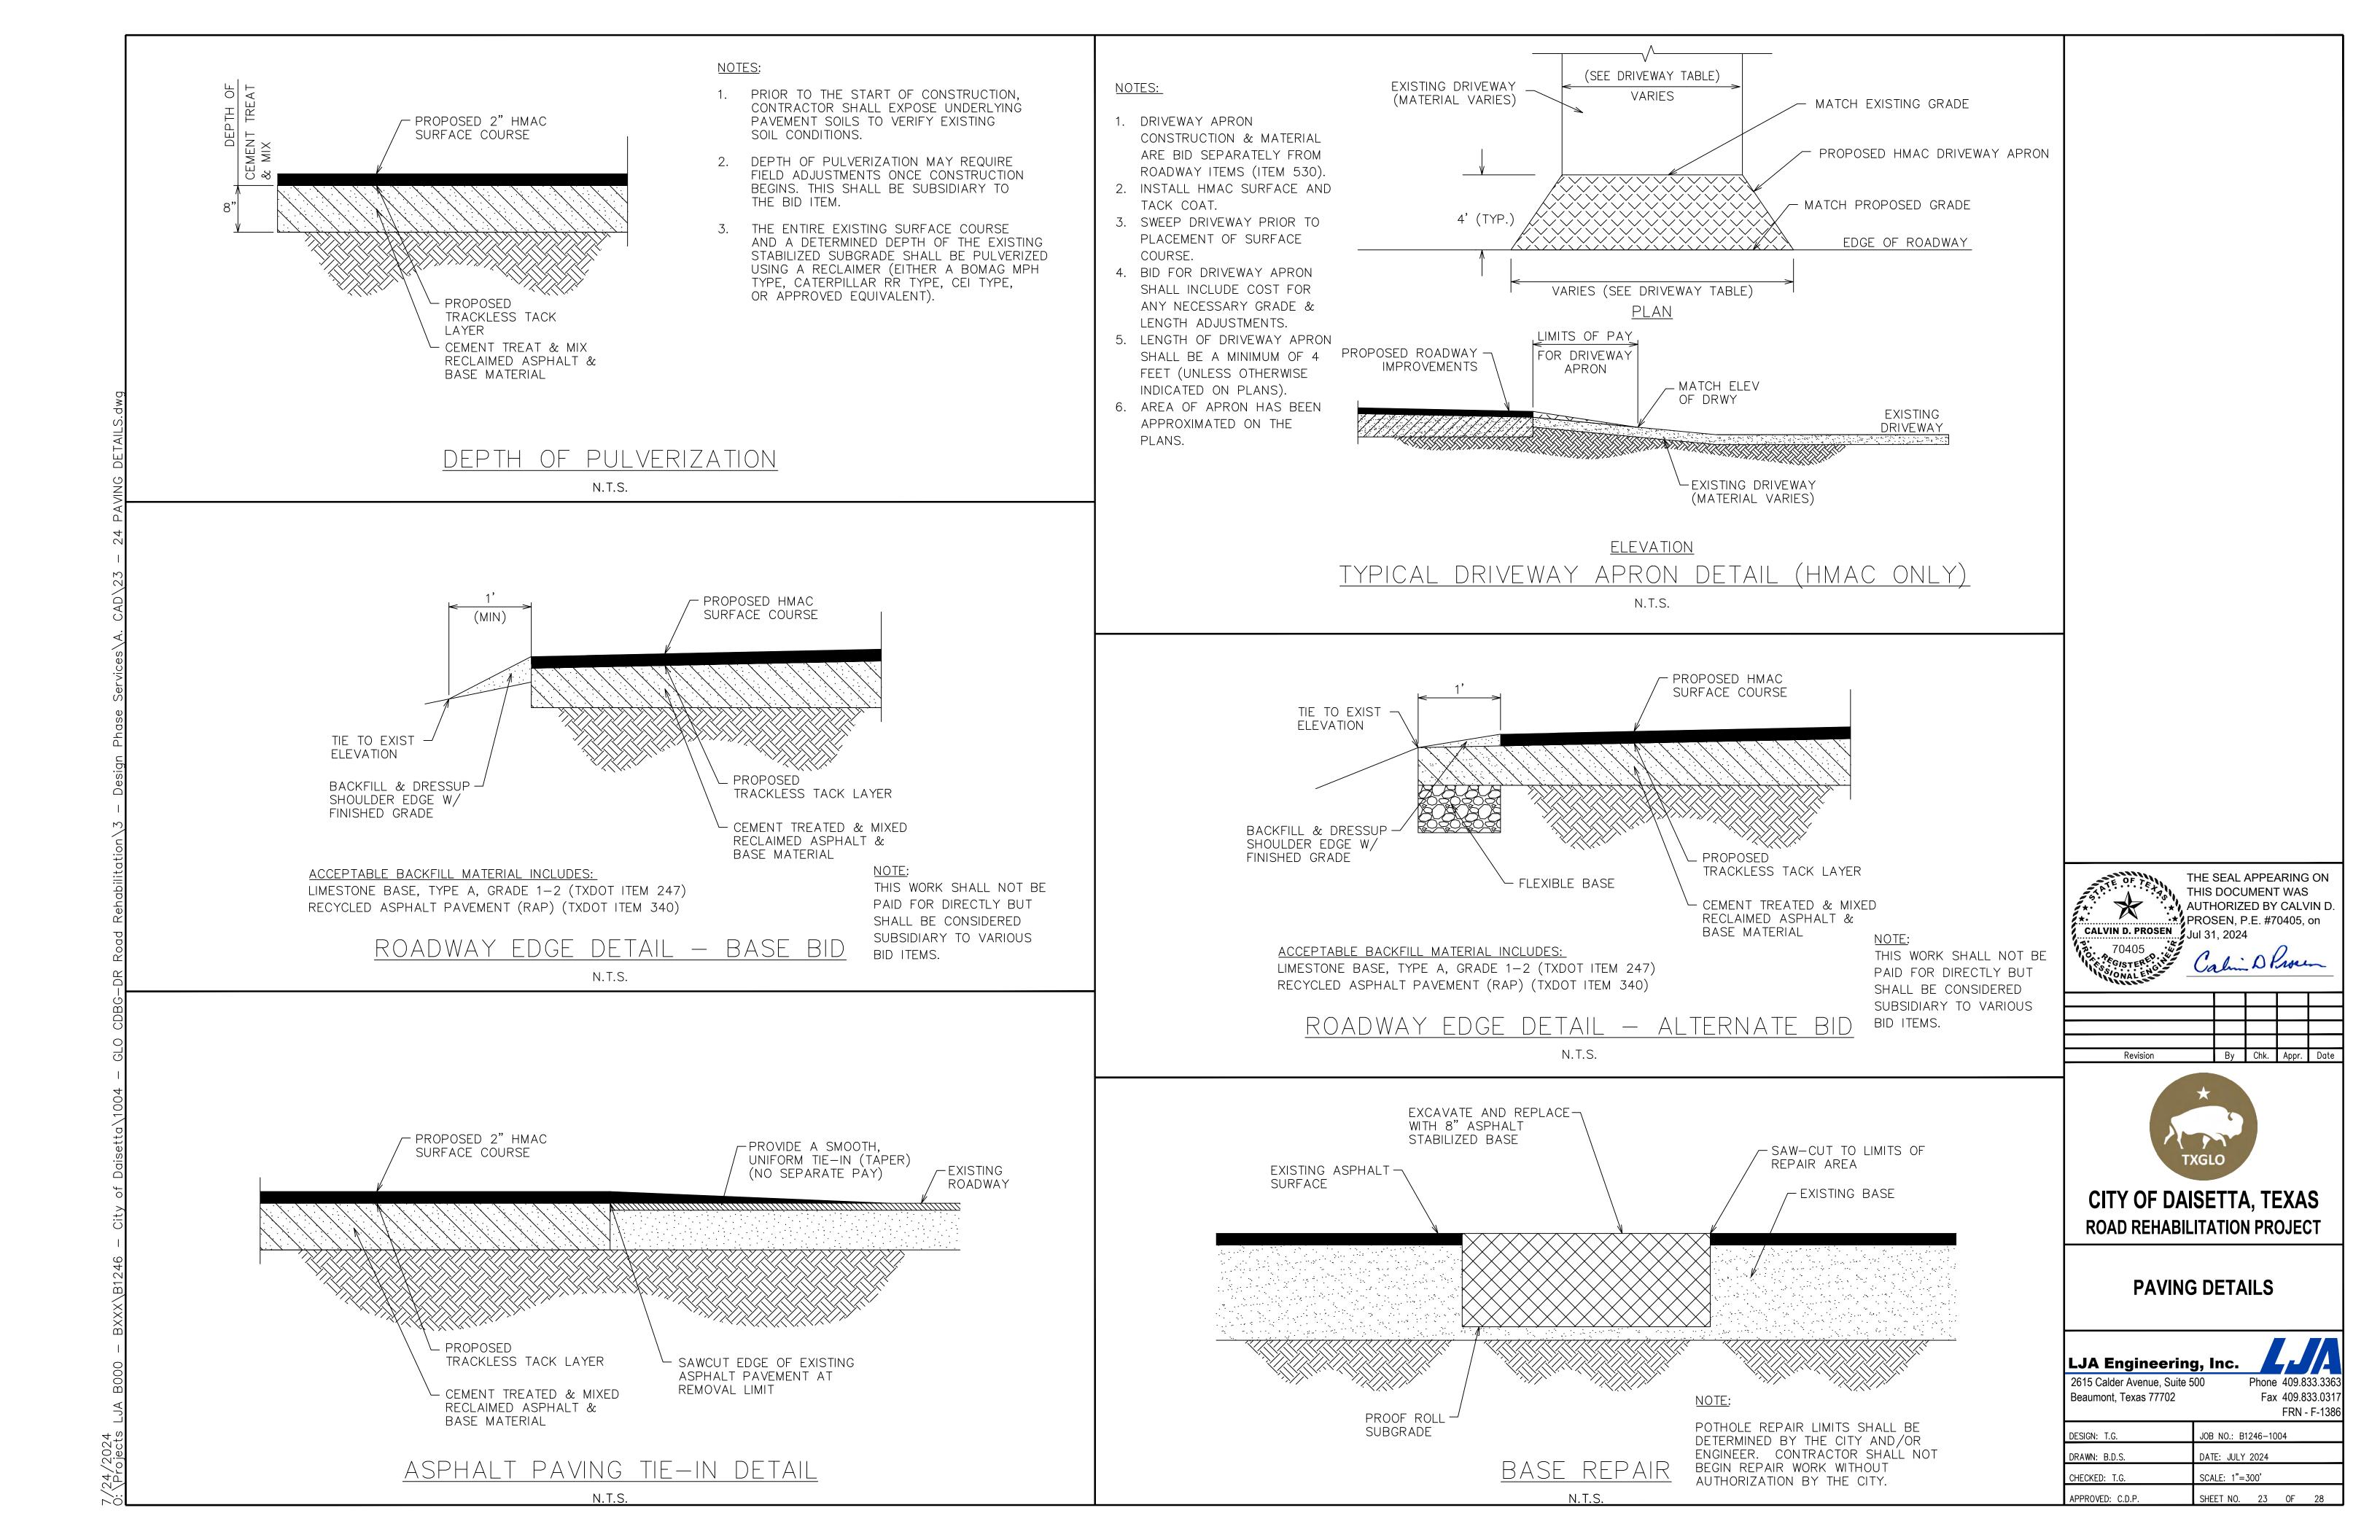

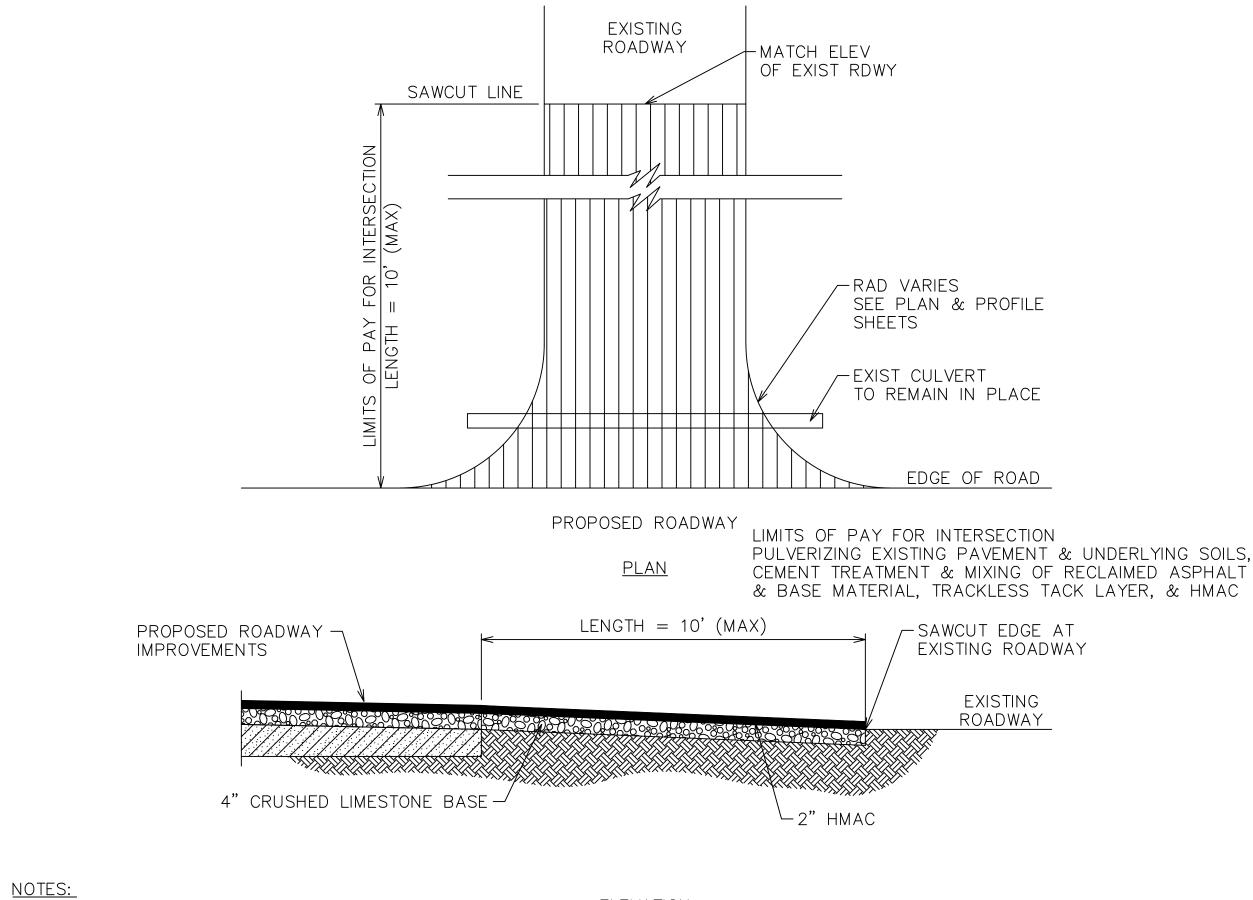

ELEVATION

1. ROADWAY INTERSECTION TURNOUT CONSTRUCTION & MATERIAL ARE BID SEPARATELY FROM ROADWAY ITEMS (ITEM 530). CONTRACTOR SHALL INSTALL HMAC SURFACE COURSE, TRACKLESS TACK AND CRUSHED LIMESTONE BASE COURSE.


3. HMAC SHALL BE TXDOT ITEM 340 (TYPE D). BASE SHALL BE TXDOT ITEM 247 (TYPE A, GR 1-2). BASE TO BE COMPACTED TO

100% STANDARD PROCTOR DENSITY DETERMINED BY ASTM D-698. MOISTURE CONTENT SHALL BE MAINTAINED AT \pm 2% OF OPTIMUM.

BID FOR ROADWAY TURNOUT SHALL INCLUDE COST FOR ANY NECESSARY GRADE & LENGTH ADJUSTMENTS.

- AREA OF INTERSECTION TURNOUT HAS BEEN APPROXIMATED ON THE PLANS.
- STORM CULVERT SHALL BE BACKFILLED PER BEDDING DETAIL AND SPECIFICATIONS.
- SWEEP AND PRIME INTERSECTING ROADWAY PRIOR TO PLACEMENT OF SURFACE COURSE. THIS WORK AND MATERIAL SHALL BE SUBSIDIARY TO VARIOUS BID ITEMS AND WILL NOT BE PAID SEPARATELY.


TURNOUT DETAIL AT ROADWAY INTERSECTION N.T.S.

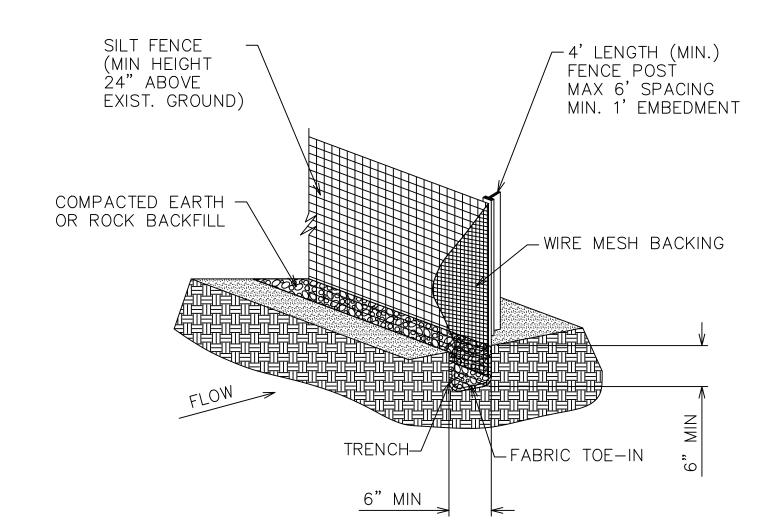


- 1. POSTS WHICH SUPPORT THE SILT FENCE SHALL BE INSTALLED ON A SLIGHT ANGLE TOWARD THE ANTICIPATED RUNOFF SOURCE. POST MUST BE EMBEDDED A MINIMUM OF ONE FOOT.
- 2. THE TOE OF THE SILT FENCE SHALL BE TRENCHED IN WITH A SPADE OR MECHANICAL TRENCHER, SO THAT THE DOWNSLOPE FACE OF THE TRENCH IS FLAT AND PERPENDICULAR TO THE LINE OF FLOW. WHERE FENCE CANNOT BE TRENCHED IN (E.G. PAVEMENT), WEIGHT FABRIC FLAP WITH ROCK ON UPHILL SIDE TO PREVENT FLOW FROM SEEPING UNDER FENCE.
- 3. THE TRENCH MUST BE A MINIMUM OF 6 INCHES DEEP AND 6 INCHES WIDE TO ALLOW FOR THE SILT FENCE FABRIC TO BE LAID IN THE GROUND AND BACKFILLED WITH COMPACTED MATERIAL.
- 4. SILT FENCE SHOULD BE SECURELY FASTENED TO EACH SUPPORT POST OR TO WIRE BACKING, WHICH IN TURN IS ATTACHED TO THE FENCE POST. THERE SHALL BE A 3 FOOT OVERLAP, SECURELY FASTENED WHERE ENDS OF FABRIC MEET.
- 5. INSPECTION SHALL BE AS SPECIFIED IN THE SWPPP. REPAIR OR REPLACEMENT SHALL BE MADE PROMPTLY AS NEEDED.
- 6. SILT FENCE SHALL BE REMOVED WHEN FINAL STABILIZATION IS ACHIEVED OR ANOTHER EROSION OR SEDIMENT CONTROL DEVICE IS EMPLOYED.
- 7. ACCUMULATED SILT SHALL BE REMOVED WHEN IT REACHES A DEPTH OF HALF THE HEIGHT OF THE FENCE. THE SILT SHALL BE DISPOSED OF AT AN APPROVED SITE AND IN SUCH A MANNER AS TO NOT CONTRIBUTE TO ADDITIONAL SILTATION

SEDIMENT CONTROL FENCE

N.T.S.

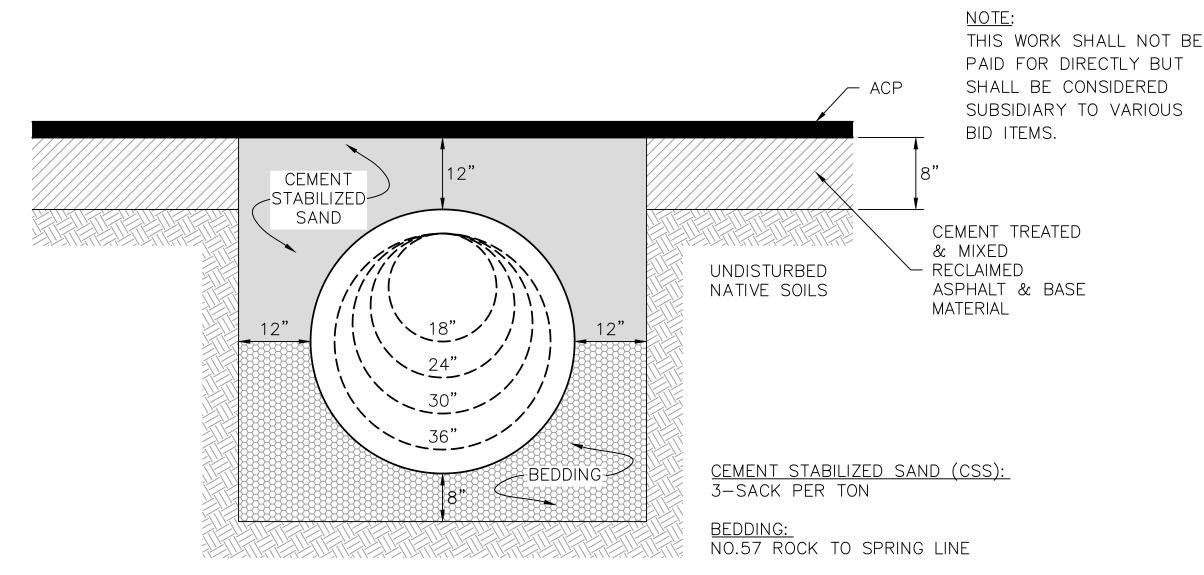


SINGLE DRAINAGE CROSSING DETAIL N.T.S.

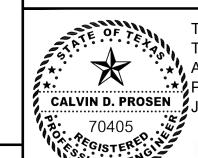

THIS DOCUMENT WAS

By Chk. Appr. Date Revision

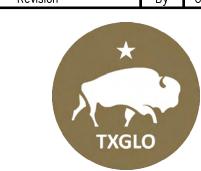

CITY OF DAISETTA, TEXAS **ROAD REHABILITATION PROJECT**

PAVING & MISCELLANEOUS DETAILS

LJA Engineering, Inc. 2615 Calder Avenue, Suite 500

Beaumont, Texas 77702


DESIGN: T.G.

DRAWN: B.D.S.

CHECKED: T.G.

JOB NO.: B1246-1004 DATE: JULY 2024 SCALE: 1"=300' APPROVED: C.D.P. SHEET NO. 24 OF 28

Fax 409.833.031 FRN - F-138

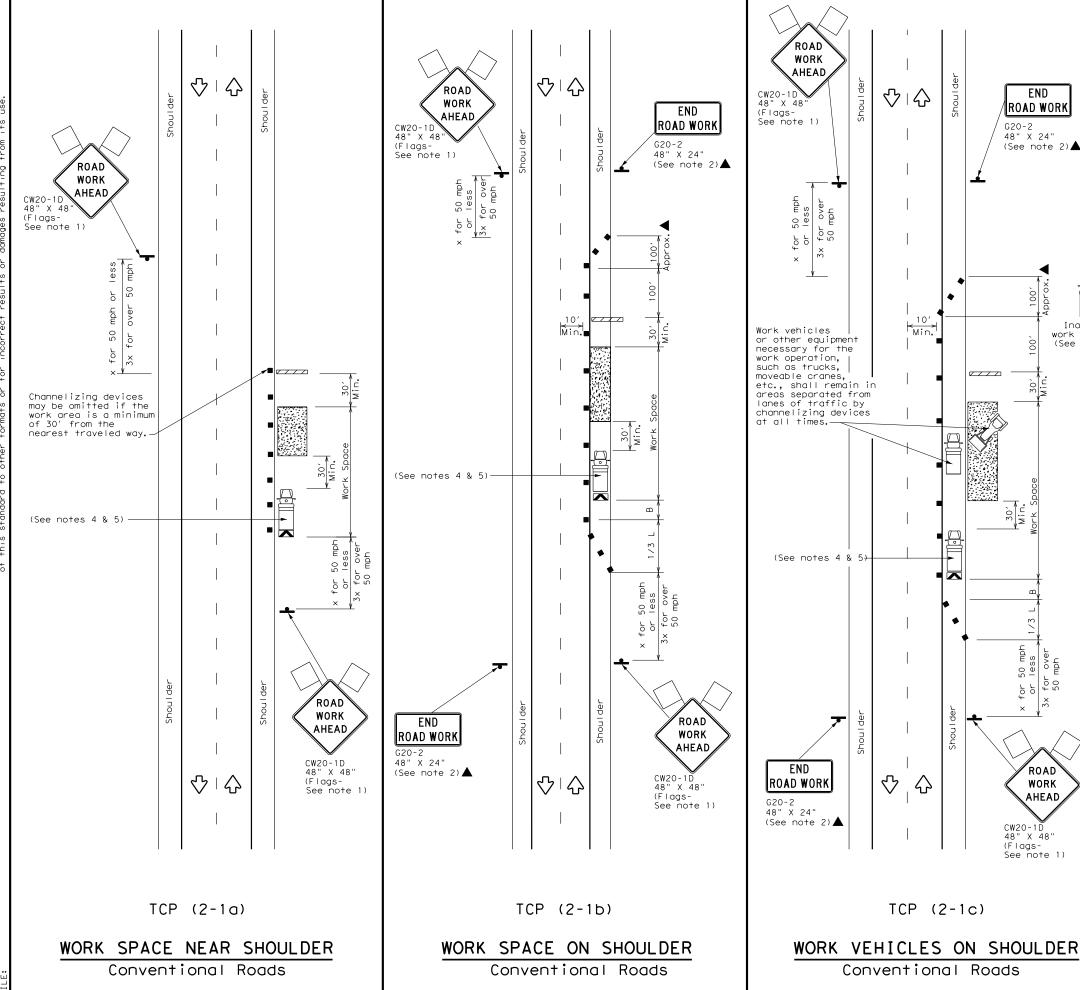

		Type 3 Heavy W	lork V				Truck	elizing (Mounted	Devices
		Trailer		ehicle				Mounted	
							Attenu	uator (Th	MA)
<u></u>			Mouri	ted		$\overline{\Box}$		ble Chan	
		· iashin	g Arr	ow Boa	rd	M	Messa	ge Sign	(PCMS)
	• :	Sign				<u>⟨</u>	Traff	ic Flow	
	\Diamond	Flag					Flagg	er	
	1		Minimu		Sugg	gested	Maximum	Minimum	1
Poste	d Formula		esirab er Len			Spacin nannel		Sign	Sugges- Longitud
Speed *	d		* *			Devi	ces	Spacing "X"	Buffer S
_^		10' Offset	11' Offset	12' Offset		n a per	On a Tangent	Distance	
30		150′	165′	180′	3	30′	60′	120′	90′
35	$L = \frac{WS^2}{60}$		225′	245′		35′	70′	160′	120
40		265′	295′	3201		10′	80′	240′	155
45		450′	495′	540′		15′	90′	320′	195
50		500′	550′	600′		0'	100′	400′	240
55	L=WS	550′	605′	660′		55′	110′	500′	295
60	_	600′	660′	720′		50'	120′	600′	350
65	\dashv	650′	715′	780′		55′	130′	700′	410
70 75	-	700′ 750′	770′ 825′	840′ 900′		'0 ' '5 '	140′ 150′	800′ 900′	475 540
X Ta	nvention per leng Length d	iths ha	ve bee	en rour	th o	f Off		S=Poste	d Speed(
	OBILE	SHOR		SHORT	TERM	N I	NTERMEDI		LONG TER
1410	ODILL	DURAT	ION	STATIO		Y TE	RM STATI	ONARY	STATIONA
CEN	ERAL N	√							✓

END

ROAD WORK

(See note 2)▲

ROAD

WORK

AHEAD

CW20-1D 48" X 48" (Flags-See note 1)

G20-2 48" X 24"

- xcept those ated in the y the Engineer.
- et from
- ashing, MA should be ance of onger present to remain in may be
- off the paved work space.
- 6. See TCP(5-1) for shoulder work on divided highways, expressways and freeways.
- 7. Inactive work vehicles or other equipment should be parked near the right-of-way line and not parked on the paved shoulder.
- 8. CW21-5 "SHOULDER WORK" signs may be used in place of CW21-1D "ROAD WORK AHEAD" signs for shoulder work on conventional roadways.





Traffic Operations Division Standard

TRAFFIC CONTROL PLAN CONVENTIONAL ROAD SHOULDER WORK

TCP(2-1)-18

FILE: tcp2-1-18.dgn	DN:		CK:	DW:		ck:
© TxDOT December 1985	CONT	SECT	JOB		HIG	HWAY
REVISIONS 2-94 4-98						
8-95 2-12	DIST		COUNTY		- 5	SHEET NO.
1-97 2-18						25

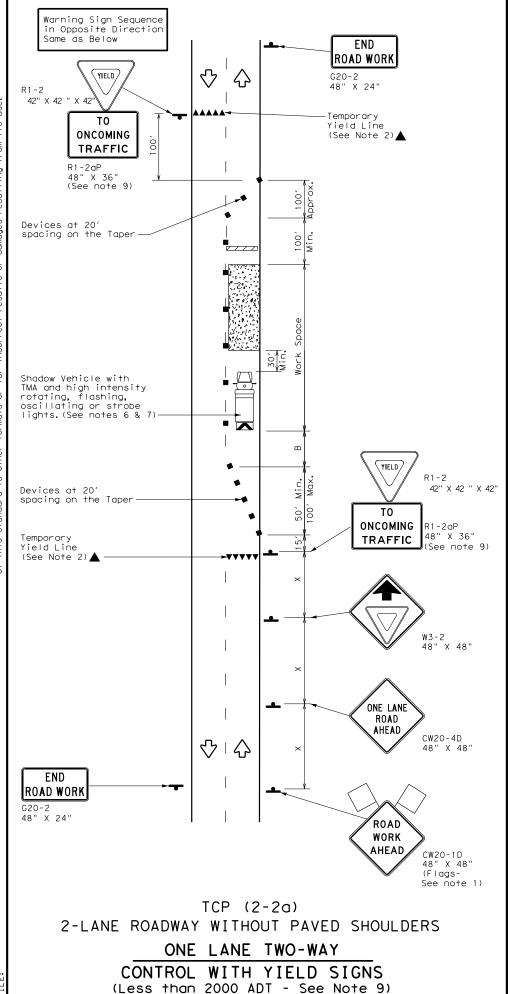

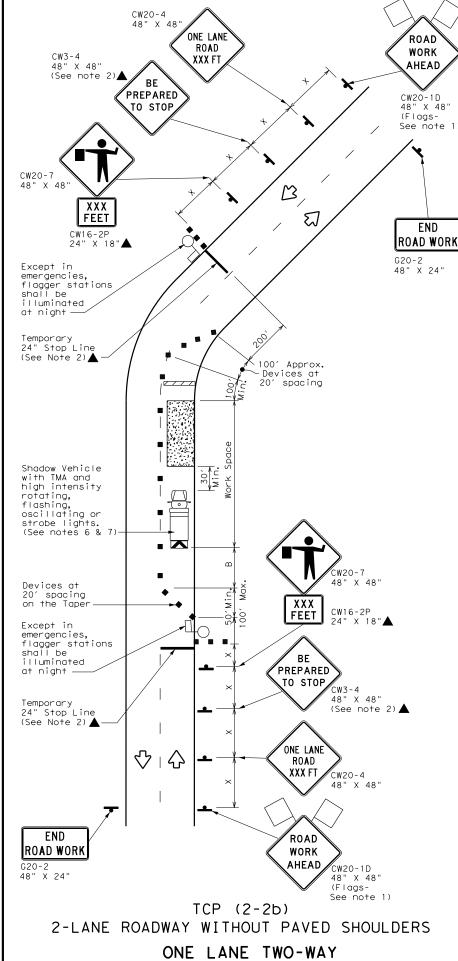

CONTROL WITH FLAGGERS

LEGEND										
	Type 3 Barricade		Channelizing Devices							
	Heavy Work Vehicle		Truck Mounted Attenuator (TMA)							
	Trailer Mounted Flashing Arrow Board	M	Portable Changeable Message Sign (PCMS)							
4	Sign	♡	Traffic Flow							
\Diamond	Flag		Flagger							

Posted Speed	Formula	D	Minimur esirab er Lend **	le	Spaci Channe		Minimum Sign Spacing "X"	Suggested Longitudinal Buffer Space	Stopping Sight Distance
*		10' Offset	11' Offset	12' Offset	On a Taper	On a Tangent	Distance	"B"	
30	WS ²	150′	165′	180′	30′	60′	120′	90′	200′
35	L = WS	205′	225′	2451	35′	70′	160′	120′	250′
40	80	265′	295′	320′	40′	80′	240′	155′	305′
45		450′	495′	540′	45′	90′	320′	195′	360′
50		500′	550′	600′	50′	100′	400′	240′	425′
55	L=WS	550′	605′	660′	55′	110′	500′	295′	495′
60	L 113	600′	660′	720′	60′	120′	600′	350′	570′
65		650′	715′	780′	65′	130′	700′	410′	645′
70		700′	770′	840′	70′	140′	800′	475′	730′
75		750′	825′	900′	75′	150′	900′	540′	820′

* Conventional Roads Only

XX Taper lengths have been rounded off.

 $\verb|L=Length| of Taper(FT) W=Width| of Offset(FT) S=Posted Speed(MPH)$

TYPICAL USAGE									
MOBILE	SHORT DURATION	SHORT TERM STATIONARY	INTERMEDIATE TERM STATIONARY	LONG TERM STATIONARY					
	_/	_/							

GENERAL NOTES

- 1. Flags attached to signs where shown, are REQUIRED.
- 2. All traffic control devices illustrated are REQUIRED, except those denoted with the triangle symbol may be omitted when stated elsewhere in the plans, or for routine maintenance work, when approved
- 3. The CW3-4 "BE PREPARED TO STOP" sign may be installed after the CW20-4 "ONE LANE ROAD XXX FT" sign, but proper sign spacing shall be maintained.
- 4. Flaggers should use two-way radios or other methods of communication to control traffic.
- 5. Length of work space should be based on the ability of flaggers to communicate.
- 6. A Shadow Vehicle with a TMA should be used anytime it can be positioned 30 to 100 feet in advance of the area of crew exposure without adversely affecting the performance or quality of the work. If workers are no longer present but road or work conditions require the traffic control to remain in place, Type 3 Barricades or other channelizing devices may be substituted for the Shadow Vehicle and TMA.
- 7. Additional Shadow Vehicles with TMAs may be positioned off the paved surface, next to those shown in order to protect a wider work space.

TCP (2-2a)

8. The R1-2 "YIELD" sign traffic control may be used on projects with approaches that have adequate sight distance. For projects in urban areas, work space should be no longer than one half city block. In rural areas, roadways with less than 2000 ADT, work space should be no longer than 400 feet.

9. The R1-2aP "YIELD TO ONCOMING TRAFFIC" sign shall be placed on a support at a 7 foot minimum mounting height.

TCP (2-2b)

- 10.Channelizing devices on the center line may be omitted when a pilot car is leading traffic and approved by the Engineer.
- 11.If the work space is located near a horizontal or vertical curve, the buffer distances should be increased in order to maintain stopping sight distance to the flagger and a queue of stopped vehicles.
- 12.Flaggers should use 24" STOP/SLOW paddles to control traffic. Flags should be limited to emergency situtations.




Traffic Operations Division Standard

TRAFFIC CONTROL PLAN ONE-LANE TWO-WAY TRAFFIC CONTROL

TCP(2-2)-18

FILE: tcp2-2-18.dgn	DN:		CK:	DW:	CK:
CTxDOT December 1985	CONT	SECT	JOB		HIGHWAY
REVISIONS 8-95 3-03					
1-97 2-12	DIST		COUNTY		SHEET NO.
4-98 2-18					26

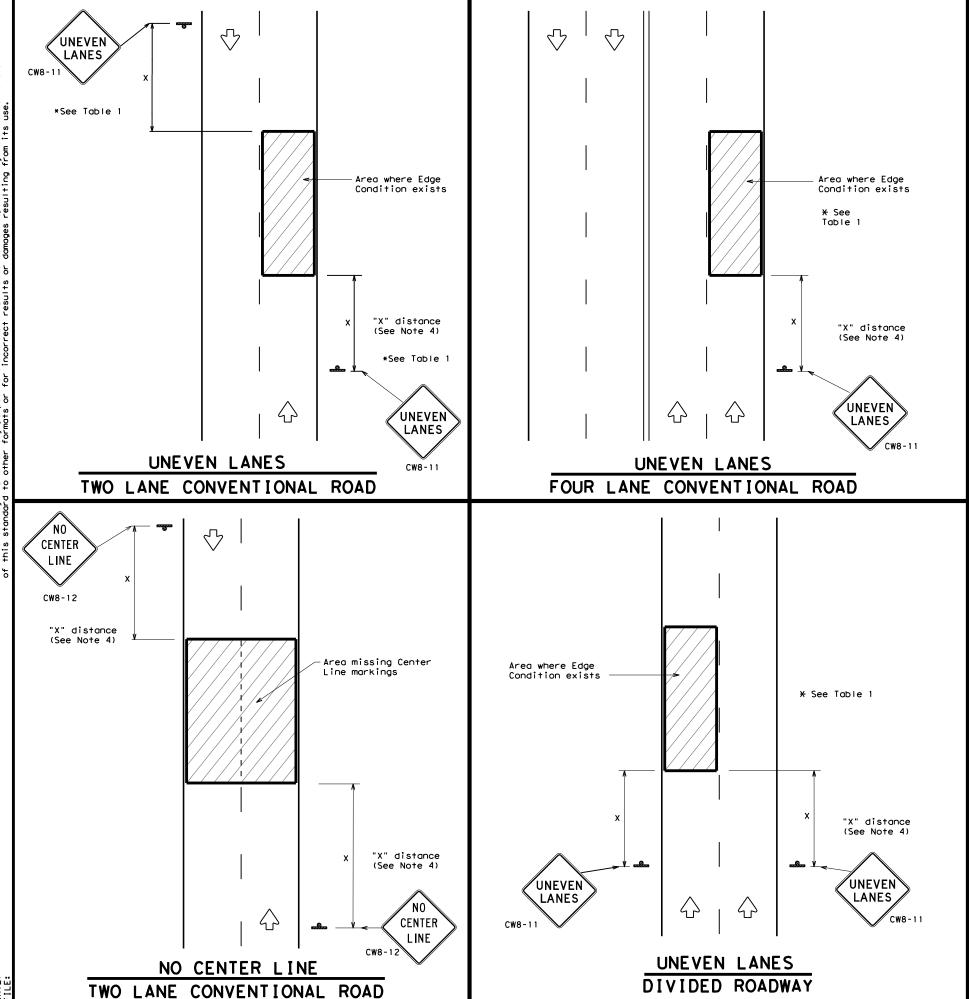

DEPARTMENTAL MATERIAL SPECIFICAT	IONS
PERMANENT PREFABRICATED PAVEMENT MARKINGS	DMS-8240
TEMPORARY (REMOVABLE) PREFABRICATED PAVEMENT MARKINGS	DMS-8241
SIGN FACE MATERIALS	DMS-8300

COLOR	USAGE	SHEETING MATERIAL
ORANGE	BACKGROUND	TYPE B _{FL} OR TYPE C _{FL} SHEETING
BLACK	LEGEND & BORDERS	ACRYLIC NON-REFLECTIVE SHEETING

GENERAL NOTES

- If spalling or holes occur, ROUGH ROAD (CW8-8) signs should be placed in advance of the condition and be repeated every two miles where the condition persists.
- UNEVEN LANES (CW8-11) signs shall be installed in advance of the condition and repeated every mile. Signs installed along the uneven lane condition may be supplemented with the NEXT XX MILES (CW7-3aP) plaque or Advisory Speed (CW13-1P) plaque.
- 3. NO CENTER LINE (CW8-12) signs and temporary pavement markings as per the WZ(STPM) standard shall be installed if yellow centerlines separating two way traffic are obscured or obliterated. Repeat NO CENTER LINE signs every two miles where the center line markings are not in place. The signs and markings shall remain in place until permanent pavement markings are installed.
- 4. Signs shall be spaced at the distances recommended as per BC standards.
- Additional signs may be required as directed by the Engineer. Signs shall remain in place until final surface is applied. Signs shall be considered subsidiary to Item 502 "BARRICADES, SIGNS AND TRAFFIC HANDLING."
- Signs shall be fabricated and mounted on supports as shown on the BC standards and/or listed on the "Compliant Work Zone Traffic Control Devices" list.
- 7. Short term markings shall not be used to simulate edge lines.
- 8. All signs shall be constructed in accordance with the details found in the "Standard Highway Sign Designs for Texas," latest edition.

	TABLE 1					
Edge Condition	Edge Height (D)	* Warning Devices				
0	Less than or equal to: 11/4" (maximum-planing) 11/2" (typical-overlay)	Sign: C₩8-11				
7777)	Distance "D" may be a maximum of 1 1/4 " for planing operations and 2" for overlay operations if uneven lanes with edge condition 1 are open to traffic after work operations cease.					
② >3 1 D	Less than or equal to 3"	Sign: CW8-11				
3 0" to 3/4" 7 D 12"	Distance "D" may be a maximum of 3" if uneven lanes with edge condition 2 or 3 are open to traffic after work operations cease. Uneven lanes should not be open to traffic when "D" is greater than 3".					
Notched Wedge Joint						

TRAFFIC CONTROL DURING PLANING, OVERLAY AND LEVELING OPERATIONS ARE SHOWN ELSEWHERE IN THE PLANS.

MINIMUM	WARNING	SIGN	SIZE
Convention	al roads	36" :	× 36"
Freeways/ex divided n	pressways, roadways	48" >	× 48"

Texas Department of Transportation

SIGNING FOR UNEVEN LANES

Traffic Operations Division Standard

WZ (UL) - 13

		_	_	_			
FILE:	wzul-13.dgn	DN: T	×DOT	ck: TxDOT	DW:	T×DOT	ck: TxDOT
C TxDOT	April 1992	CONT	SECT	JOB		HIG	CHWAY
	REVISIONS						
8-95 2-98	7-13	DIST		COUNTY			SHEET NO.
1-97 3-03							27

Shou I der

4" Solid

Edge Line-


4" Solid

4" Solid White

Edge Line-


White Edge Line

Yellow

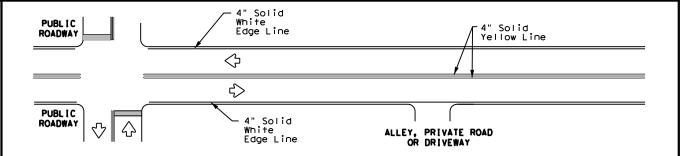

TYPICAL TWO-LANE, TWO-WAY PAVEMENT MARKINGS THROUGH INTERSECTIONS

TYPICAL MULTI-LANE, TWO-WAY PAVEMENT MARKINGS THROUGH INTERSECTIONS

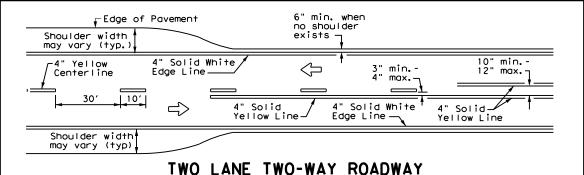

WITH OR WITHOUT SHOULDERS

-6" min.

_6" min.

10′

3" min.-4" usual

(12" max. for

traveled way

10′

 \Rightarrow

 $\overline{}$

 \Rightarrow

-Edge of Pavement

EDGE LINE AND LANE LINES

ONE-WAY ROADWAY

WITH OR WITHOUT SHOULDERS

-Edge of Pavement

— 4" White J

Lane Line

4" Solid Yellow Line-

4" Solid White

CENTERLINE AND LANE LINES

FOUR LANE TWO-WAY ROADWAY

WITH OR WITHOUT SHOULDERS

 \Rightarrow



YIELD LINES

Pavement Edge $\langle \neg$ 4" Solid White 4" White Lane Line_ Edge Line 4" Solid Yellow 10′ -4" Solid Yellow Line Edge Line -See Note 2-—See Note 1-10" min. Taper max. Optional 8" Solid White Line Dotted 8" White ΔΔΔΔΔΔΙ Extension See note 3 **4**48" min. from edge Triangles line to 4" Solid Yellow stop/yield Storage Edae Line Deceleration ___ 4" Solid White \Rightarrow White Lane Line Edge Line —

FOUR LANE DIVIDED ROADWAY CROSSOVERS

NOTES


- 1. Where divided highways are separated by median widths at the median opening itself of 30 feet or more, median openings shall be signed as two separate intersections. Each median opening has two width measurements, with one measurement for each approach. The narrow median width will be the controlling width to determine if signs are required. Yield signs are the typical intersection control. Stop signs are optional as determined by the Engineer.
- Install median striping (double yellow centerlines and stop bars/yield triangles) when a 50' or greater median centerline can be placed. Stop bars shall only be used with stop signs. Yield traingles shall only be used with yield signs.
- Length of turn bays, including taper, deceleration, and storage lengths shall be as shown on the plans or as directed by the Engineer.

GENERAL NOTES

- Edgeline striping shall be as shown in the plans or as directed by the Engineer. The edgeline should not be placed less less than 6 inches from the edge of pavement. This distance may vary due to pavement raveling or other conditions. Edgelines are not required in curb and gutter sections of roadways.
- 2. The traveled way includes only that portion of the roadway used for vehicular travel. It does not include the parking lanes, sidewalks, berms and shoulders. The traveled ways shall be measured from the inside of edgeline to the inside of edgeline of a two lane roadway.

MATERIAL SPECIFICATIONS	
PAVEMENT MARKERS (REFLECTORIZED)	DMS-4200
EPOXY AND ADHESIVES	DMS-6100
BITUMINOUS ADHESIVE FOR PAVEMENT MARKERS	DMS-6130
TRAFFIC PAINT	DMS-8200
HOT APPLIED THERMOPLASTIC	DMS-8220
PERMANENT PREFABRICATED PAVEMENT MARKINGS	DMS-8240


All pavement marking materials shall meet the required Departmental Material Specifications as specified by the plans.

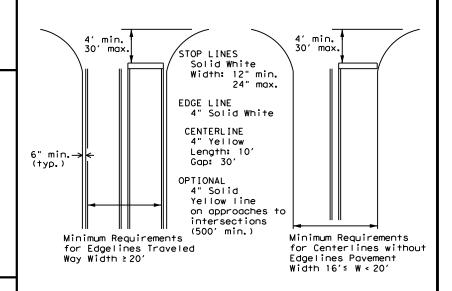

GUIDE FOR PLACEMENT OF STOP LINES, EDGE LINE & CENTERLINE

Based on Traveled Way and Pavement Widths for Undivided Highways

5-00 2-12 8-00 6-20

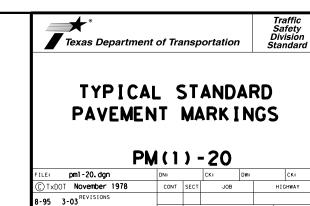

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